

NSW Housing Pattern Book

SMALL LOT APARTMENTS O2 by Nguluway DesignInc

A sculptural apartment building with earthy material palette and thoughtful in-between spaces for neighbours to connect with Country and each other



About this document

This document explains the specific requirements for the pattern called **Small Lot Apartments 02 by Nguluway DesignInc**. This pattern is part of the NSW Housing Pattern Book as referred to in the State **Environmental Planning Policy** (Housing) Amendment (Midrise housing patterns) 2025.

The document provides an overview of what this pattern offers. It explains where housing based on this pattern can be located and how the design can be adjusted to suit user preferences and site requirements within the development standards defined for this pattern.

The technical drawings describe the pattern design in detail. Once you have selected a suitable pattern and paid the administrative fee, you can download the digital drawing package in DWG format for use by your architect or accredited designer to prepare your development application.


Using the pattern book

You are here:

Explore patterns and engage a designer Explore the patterns available on the NSW Housing Pattern Book website and identify which ones might be suitable to your site and requirements. If you decide to proceed, engage an architect or building designer who will be able to support you through the pattern book development process.

- Select a pattern and adapt it to your site and preferences
- Prepare drawings and information for a planning application
- Understand the streamlined development application pathway
- 5 Lodge your application through the streamlined development application process

Related documents and supporting information

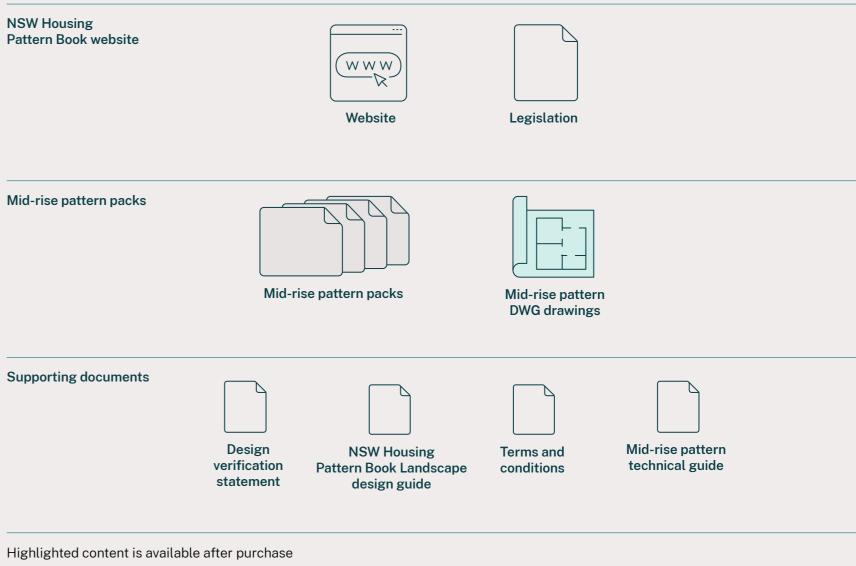

NSW Housing Pattern Book Small Lot Apartments 02 by Nguluway DesignInc

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Note: When you pay the fee you will receive technical drawings in PDF and DWG formats, technical guidance, an editable design verification statement and your unique identification number.

^{*}Drawing will be available in DWG format.

SMALL LOT APARTMENTS 02

by Nguluway DesignInc

The architects designed:

A family-friendly apartment building that is adaptable to a range of settings in NSW

Earthy materials and colours that reflect and respond to local Country

A mix of generous 1-bedroom, 2-bedroom and 3-bedroom homes designed for comfortable living

Communal spaces on each level that act as 'brackish' spaces that support connecting to Country and foster neighbourly ties

Integrated sustainability including solar access, cross-ventilation, rainwater tanks and rooftop solar panels

Homes that reflect and respond to the NSW Apartment Design Guide for the benefit of future residents



About this pattern

Site suitability – Suits an infill mid-block site

Optimal orientation – Designed to adapt to a range of orientations

Development type – Residential flat building

Permissibility – Transport-oriented development areas and in low and mid-rise housing areas

Ownership – Suitable for strata, company title or build to rent

No. of storeys - 3 or 4

No. of dwellings - 6 to 14


Mix of dwelling types –1 to 3-bedrooms

Site width – Suits minimum lot width between 13.6–16.6 m


Site length – Suits minimum lot length between 42–52 m

Site area – Suits lot area between 571–863 m²

Third floor

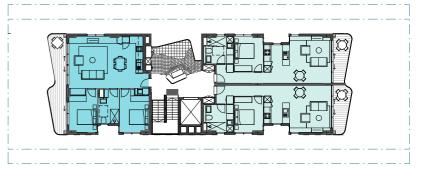


Second floor

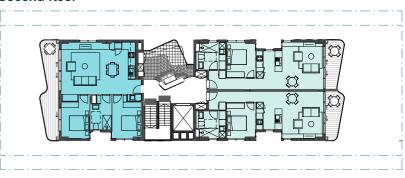


First floor



Ground floor

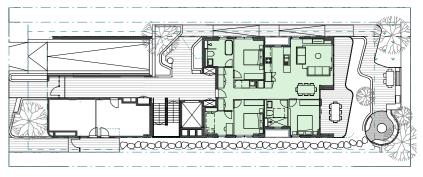

Basement

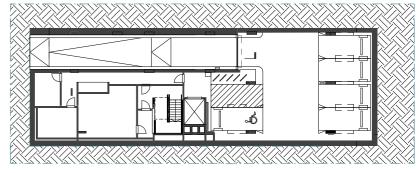


Studio

One bedroom

Two bedroom

Not to scale

4

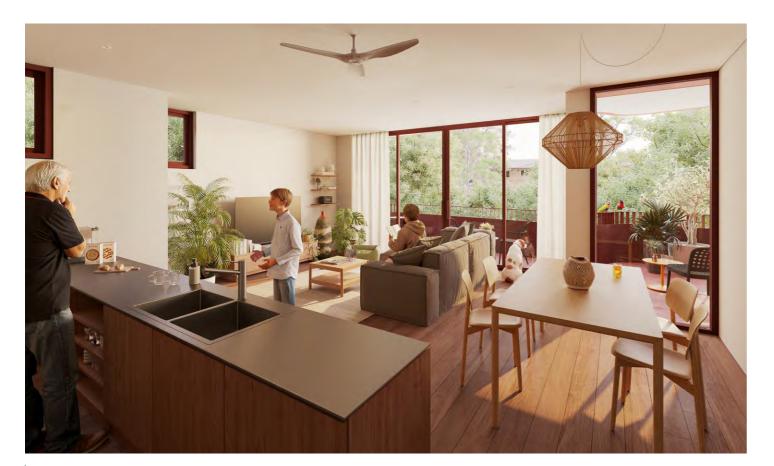

Easy to live in

Interior view of the kitchen and living areas looking onto the balcony

The pattern is designed for a wide range of households and lifestyles, with a strong focus on community and shared common areas within the apartment building. This pattern would suit:

Single and couples–spacious 1-bedroom apartments and good communal space to connect with neighbours

New parents and families – welldesigned 2-bedroom apartments with generous balconies and 3-bedroom apartments with flexible rooms that could be used as a nursery or playroom

Co-living and multigenerational families – the compact building design would suit families living side by side in their own selfcontained apartment

Downsizers – several apartments are designed for easy adaptation to support mobility, access and aging in place

► Refer to A-370 series for full range of apartment types

Base pattern mix	Studio	1-bed	2-bed	3-bed	4-bed
Number of dwellings	_	4	3	2	_
Bedrooms per dwelling	_	1	2	3	_
Bathrooms per dwelling	_	1	1	2	_
Floor area per dwelling	_	63.5 m ²	75 m²	118 m²	_

Example 2-bed apartment




Example 1-bed apartment



Not to scale


For everyone and every place

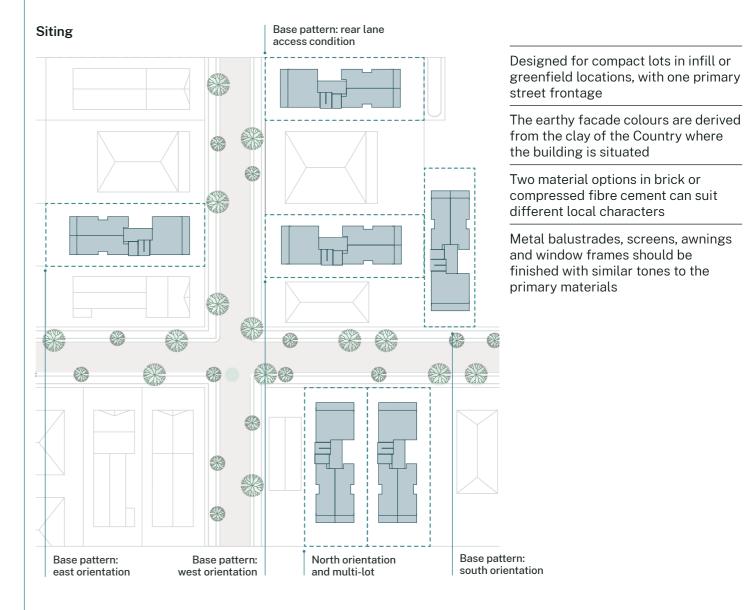

Brick in variable, earthy colours



Compressed fibre cement sheet in variable colours

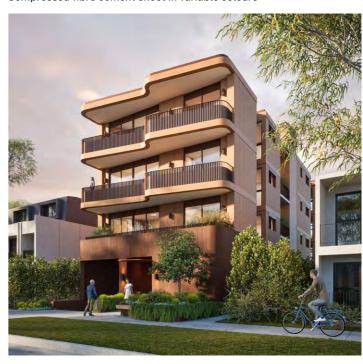

NSW Housing Pattern Book Small Lot Apartments 02 by Nguluway DesignInc

Sustainable and energy efficient

Designed for compact sites and ideal for infill development

Passive solar design keeps homes comfortable and lowers energy bills

Daylight and cross-ventilation create healthy homes


The roof area allows for extensive solar panel installation

External materials have longevity for an enduring and low-maintenance home

Rainwater tanks collect and reuse roof water

Ceiling fans improve comfort and energy efficiency

All-electric dwellings provide healthier indoor environments, lower energy bills, and a smaller carbon footprint

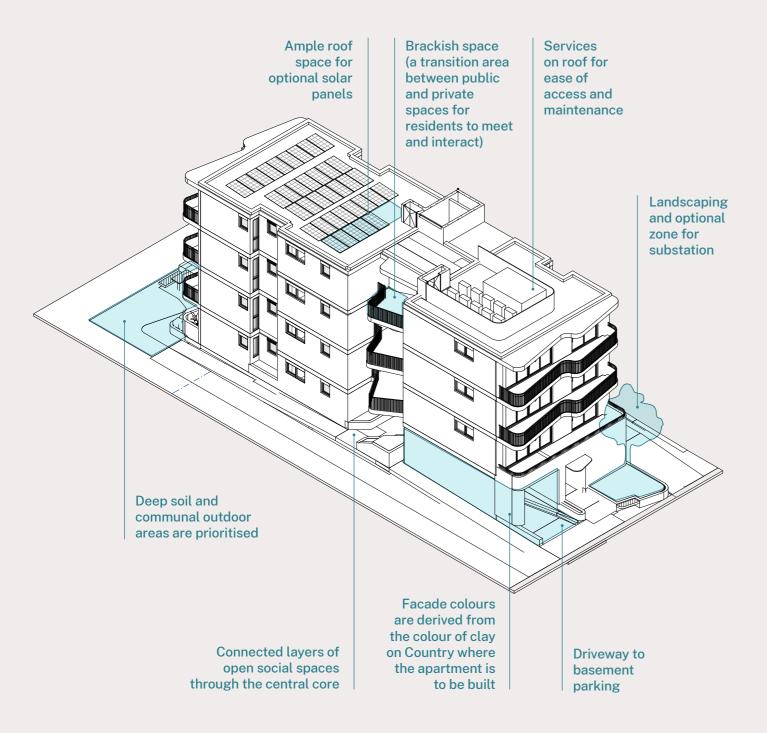



Smart and flexible

'Brackish space' where residents can meet and interact

This pattern can be built as a 3-storey building with a minimum lot width of 13.6 m and 1.5 m side setback


This pattern can also be built as a 4-storey building with minimum lot width of 16.6 m and 3 m side setback

Basement parking provided to suit site conditions and user preference

Two earthy material palettes draw on the colours of local clays

The design can accommodate slopes of up to 1.66 m and adapt to longer sites up to 52 m

Joinery elements are indicative and can be adapted to suit the end user

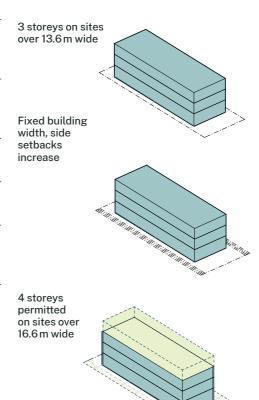


Building and site length adaptations

NSW Housing Pattern Book Small Lot Apartments 02 by Nguluway DesignInc

SMALL LOT APARTMENTS 02 by Nguluway DesignInc

Requirements and adaptations

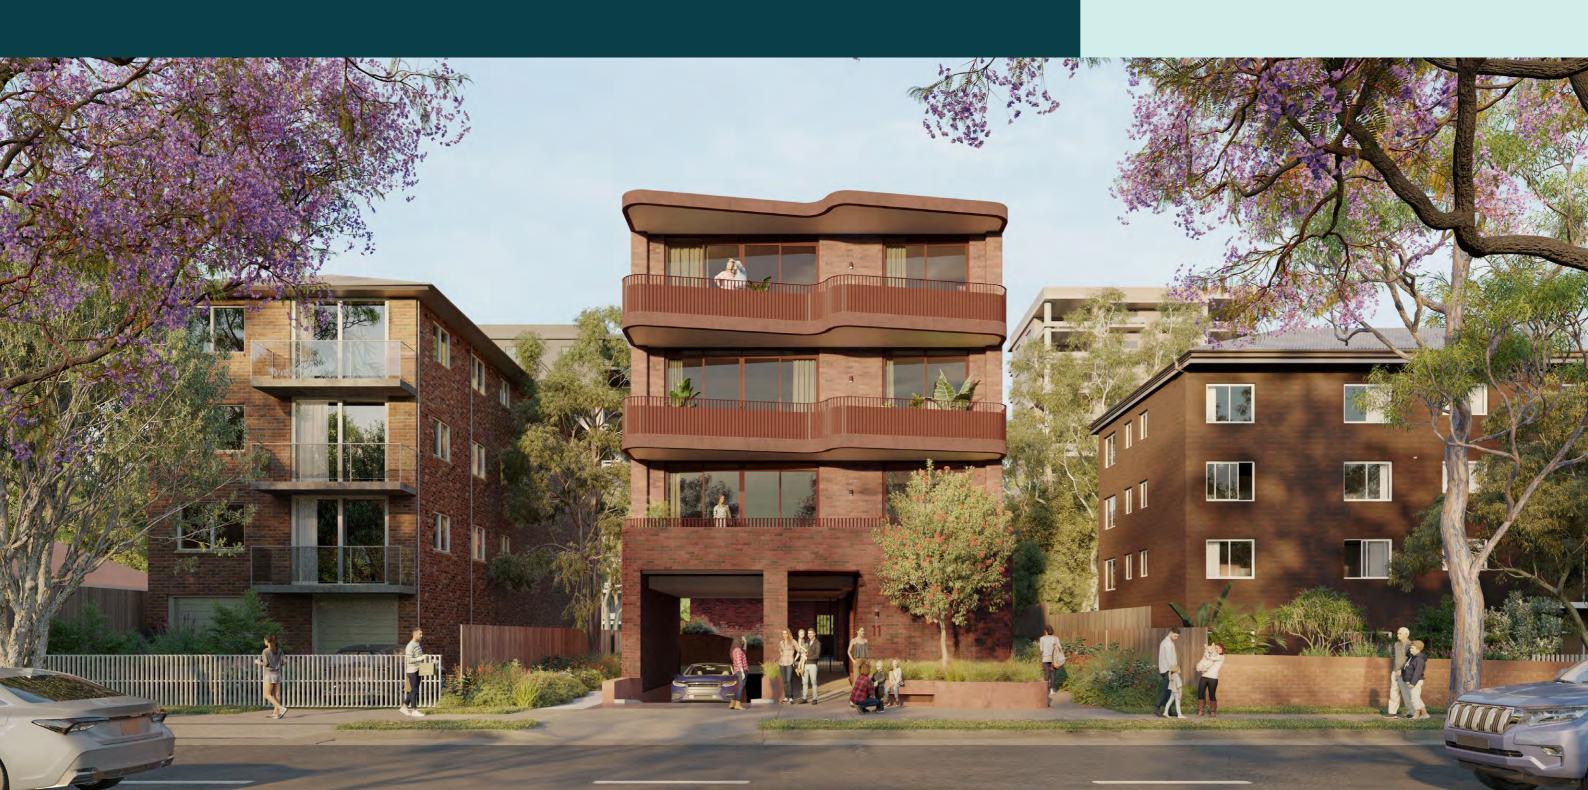

Planning overview

Planning pathways for pattern book developments

Developments using the mid-rise housing patterns must be submitted under Chapter 7 Pattern book development in State Environmental Planning Policy (Housing) 2021 (the Housing SEPP). This chapter includes provisions for mid-rise housing pattern development to be eligible for a reduced assessment period for development application (DA).

Excluded land

The proposed SEPP does not apply to land affected by certain hazards and constraints that have been identified by the Department as unsuitable for the policy. This land includes: bushfire-prone and certain floodprone land in high risk locations, State heritage items, local heritage items and heritage conservation areas. To understand the full list of exclusions refer to Chapter 7 Pattern book development in the Housing SEPP.

Design verification statement

Pattern book development applications must include a written statement known as the NSW Housing Pattern Book design verification statement mid-rise (DVS mid-rise) completed by a qualified designer (i.e. an architect) in accordance with Environmental Planning and Assessment Regulation 2021. A template of this statement can be found on the NSW Housing Pattern Book website and is included in the download package when purchasing a pattern.

The DVS mid-rise must confirm the proposed development will comply with the development standards, location requirements, technical drawing set and technical information specific to the proposed pattern. The architect must confirm that all fixed and adaptable design features required by the pattern are evident in the submitted development application.

The statement will help the consent authority to determine whether a proposed development complies with the original pattern design and is eligible to be considered pattern book development.

Qualified designer

The design verification statement (mid-rise housing patterns) must be completed by a qualified designer which is defined as an architect registered by the NSW Architects Registration Board under the Architects Act 2003. They must include their professional registration details in the statement.

Note to assessors

To be considered pattern book development, a development application using a mid-rise housing pattern must meet the required planning obligations. This includes complying with development standards, location requirements, and technical drawing set and technical information included in the pattern, as verified in the design verification statement (mid-rise housing patterns).

Design integrity

The design integrity of the pattern must be reflected in the submitted design. The submitted design should not be modified beyond the defined adaptations and parameters of the pattern.

Apartment Design Guide

This pattern design has been developed with reference to the Apartment Design Guide (ADG) and having undergone rigorous review has been endorsed as having considered the ADG. The development standards and pattern requirements in this document ensure that developments using this pattern can achieve the 9 design quality principles identified in Schedule 9 of the housing SEPP. Further assessment against Schedule 9 or the ADG is therefore not required for pattern developments.

Landscape and significant trees

As well as meeting landscape-related development standards set out below, pattern book developments must show how they have considered the NSW Housing Pattern Book *Landscape design guide* which provides advice on creating a landscape plan for the patterns and includes suggested planting lists. This includes consideration of tree canopy requirements.

Sites requiring change or removal or pruning of significant trees or vegetation must seek any necessary approvals from the relevant council in accordance with their requirements.

The NSW Housing Pattern Book Landscape design guide can be downloaded from the NSW Housing Pattern Book website for additional information.

Privacy

Privacy has been addressed within the pattern designs with solutions provided including fixed and optional screening and required setbacks to accommodate appropriate building separation.

Cross-ventilation

All apartments achieve crossventilation in accordance with guidance in the ADG.

Sustainability

Consistent with all residential developments in NSW, pattern book developments must demonstrate how they meet Building Sustainability Index (BASIX) and Nationwide House Energy Ratings Scheme (NatHERs) targets and compliance. Each pattern includes guidance on how to achieve these requirements, along with optional sustainability features such as solar panels and upgraded performance features.

► Refer to the Mid-rise pattern book technical guide for details.

Height and density bonuses under environmental planning instruments

Any application of height or density bonuses under an environmental planning instrument, such as the Affordable Housing Bonus (State Environmental Planning Policy (Housing) 2021), must be accommodated within the maximum height variation of this pattern.

NSW Housing Pattern Book Small Lot Apartments 02 by Nguluway DesignInc

Development standards and planning information for Small Lot Apartments 02 by Nguluway DesignInc

Planning requirements

Developments applying this design from the pattern book must adhere to the planning requirements specified below to be eligible to be assessed as pattern development under Chapter 7 Pattern Book Development in the Housing SEPP. The development standards and location requirements for this pattern prevail in the case of any inconsistency with equivalent development standards in other relevant environmental planning instruments (i.e. SEPP or LEP) or equivalent requirements in a Development Control Plan.

Development type

Residential flat building

Applicability

Permitted in low and mid-rise (LMR) housing areas under section 163 of the Housing SEPP and transportoriented development (TOD) housing areas under Chapter 5 of the Housing SEPP where this type of development is permissible with consent.

Development standards

The following development standards are specific to Small Lot Apartments 02 by Nguluway DesignInc. They apply where this pattern is proposed as pattern book development under Chapter 7 Pattern Book Development in the Housing SEPP.

Location requirements (site response)

Solar access

All pattern book developments need to demonstrate that adequate solar access to 70% of residential apartments (2 hours of direct sunlight to living spaces between 8am to 4pm) can be achieved in response to site conditions. This pattern can achieve at least 70% solar access between 8am to 4pm and has been tested under a common set of conditions which are explained in siting and technical information sections of this document.

Overshadowing

All pattern book developments need to minimise overshadowing impacts to neighbouring sites. Neighbouring sites should receive a minimum 3 hours of sunlight to at least 50% of private open space areas between 9am and 3pm on 21 June. Overshadowing impacts must be evidenced in the DA submission through sun shadow diagrams.

Setbacks may need to be increased to maximise solar access and to minimise overshadowing from adjoining buildings.

Site type

This pattern can only be used in a mid-block site and is not adaptable to corner lots.

Development standards

Maximum no of storeys 4

Maximum no of dwellings

no more than 75% of which to be a single type

Maximum building height (m) from ground level (existing)

17.5 m

See exclusions in notes (to right Pattern development must also comply with maximum building height requirements of the relevant EPI

Con evaluaione in notes (to right)

	See exclusions in	n notes (to right)
	3 storeys minimum pattern	4 storeys base pattern
Minimum lot size	571 m ²	863 m ²
Minimum lot width	13.6 m	16.6 m
Minimum side setbacks	1.5 m	3.0 m
Minimum front setback (primary street frontage)		4.0 m
Minimum rear setback	6.0 m	6.0 m
Minimum floor to ceiling height in dwellings	2.7 m (habitable 2.4 m (non-habita	-
Minimum deep soil area	7% = <650 m ² sit 10% = 650 –1,500 15% = >1,500 m ² s	m² site area

Mode: kerbside

(minimum requirement) Frequency: weekly

Notes on development standards for this pattern

These notes are intended to be read in conjunction with the pattern adaptations and technical drawings for this pattern.

Storeys

The maximum number of storeys for this pattern refers to habitable storeys and does not include rooftop facilities.

Height

For the purposes of this pattern the maximum building height does not apply to lift overruns and plant and services equipment. The exclusions from maximum height of building (lift overrun etc) will require additional 1.84 m of height. These are designed to have no overlooking or overshadowing impact on neighbouring amenity. The maximum building height for the pattern development standards includes allowance for adaptation to slope on the subject site.

Lot and

The pattern adaptations in the technical requirements drawings section provide guidance on adapting the base plan for different site adaptations sizes, positions (mid-block, laneway), orientations and inclusions.

Irregular lot Patterns can be adapted to irregular **adaptations** shaped sites, excluding battle-axe lots. subject to meeting the minimum setback requirements.

width

Minimum lot The minimum lot width is measured at the front of the building line.

Waste


The pattern requires weekly kerbside collection with wheel-out wheel-in by building management to collection area as shown in the technical drawings section. The base pattern accommodates bin and bulky waste room areas in accordance with the calculation rates provided in this document.

NSW Housing Pattern Book Small Lot Apartments 02 by Nguluway DesignInc

Waste collection

Healthy relationships with Country

At its heart, the building personifies the cultural understanding that we are not separate to nature, or each other. Instead, we belong to each other and nature-instilling the truth of Belonging to Country in design.

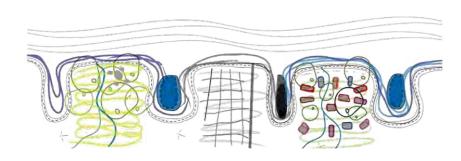


Regenerate and connect natural environments




Building grounded in earth, reflect the colours of Country

Threshold magic

The building examines the opportunities that arise from blurring boundaries between neighbours, creating connected communities and ecosystems, and blurring boundaries between indoors and outdoors, creating spaces where people can connect and interact with nature and with each other.

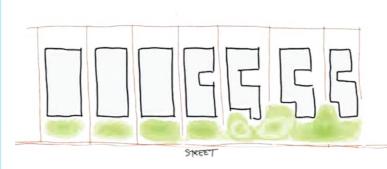


Blur boundaries between neighbours

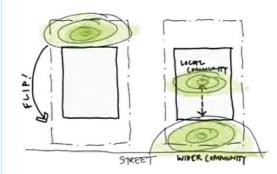


Blurring boundaries between indoors and outdoors

Communal 'brackish spaces'

The design interprets 'brackish spaces' as communal meeting spaces provided on every level of the building. The stairwells, breezeways, courtyards and gardens invite incidental encounters and purposeful gathering, facilitating connection, and countering isolation.

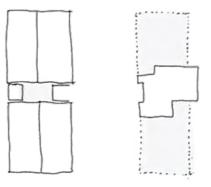

Make remnant circulation spaces active communal spaces

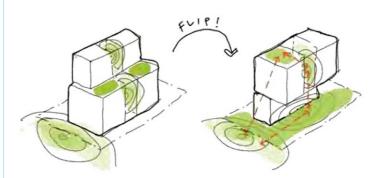

Connect layers of communal space throughout the building

Concept design

This page provides an overview of the design concepts that underpin this pattern. It includes key features of the structure and form, provision of communal space, approach to adaptation and any other matters highlighted by the architects.

An old Dharawal story speaks of the confluence of Freshwater and Saltwater Country, known as 'brackish space' and of the magic that unfolds in their meeting. This page provides an overview of this story has been embedded into the design of this pattern.

Diverse apartment mix 'Brackish' common **Generous interior** A diverse apartment space layouts mix on each level Communal areas on Light-filled interiors suits a wide range of all levels comprise have generous, 28% of the site, naturally ventilated household types supporting connection living areas and community Number of storeys Suitable for 3 storeys on a minimum 13.6 m-wide lot with 1.5 m side setback, or 4 storeys on a minimum 16.6 m-wide lot with 3 m side setback Services and waste provisions Waste rooms sized for weekly kerbside collection; provision for substation and fire pump room Site size and slope The design adapts to site Adaptable interior Country-centred design conditions including Selected apartments **Furniture layouts** Two material options and an 0-1.66 m for slope can be adapted Joinery elements **Parking** earthy colour palette respond (either up or down) to Australian are indicative and Entrance to to the Country where the and to longer site Standard 4299-1995 can be adapted to building is located basement parking lengths up to 52 m Adaptable Housing suit the end user

Design features

This page shows key features of the pattern including form and structure, services, communal space, sustainable features and any other matters highlighted by the architects.


The features on this page are coloured to show the following:

- Fixed features these must be strictly retained in the planning application.
- Flexible features these items can be modified within the agreed parameters shown in the drawings.

Any changes to the pattern design, including flexible features, must be declared in the design verification statement as part of the planning application.

NSW Housing Pattern Book

Small Lot Apartments 02 by Nguluway DesignInc

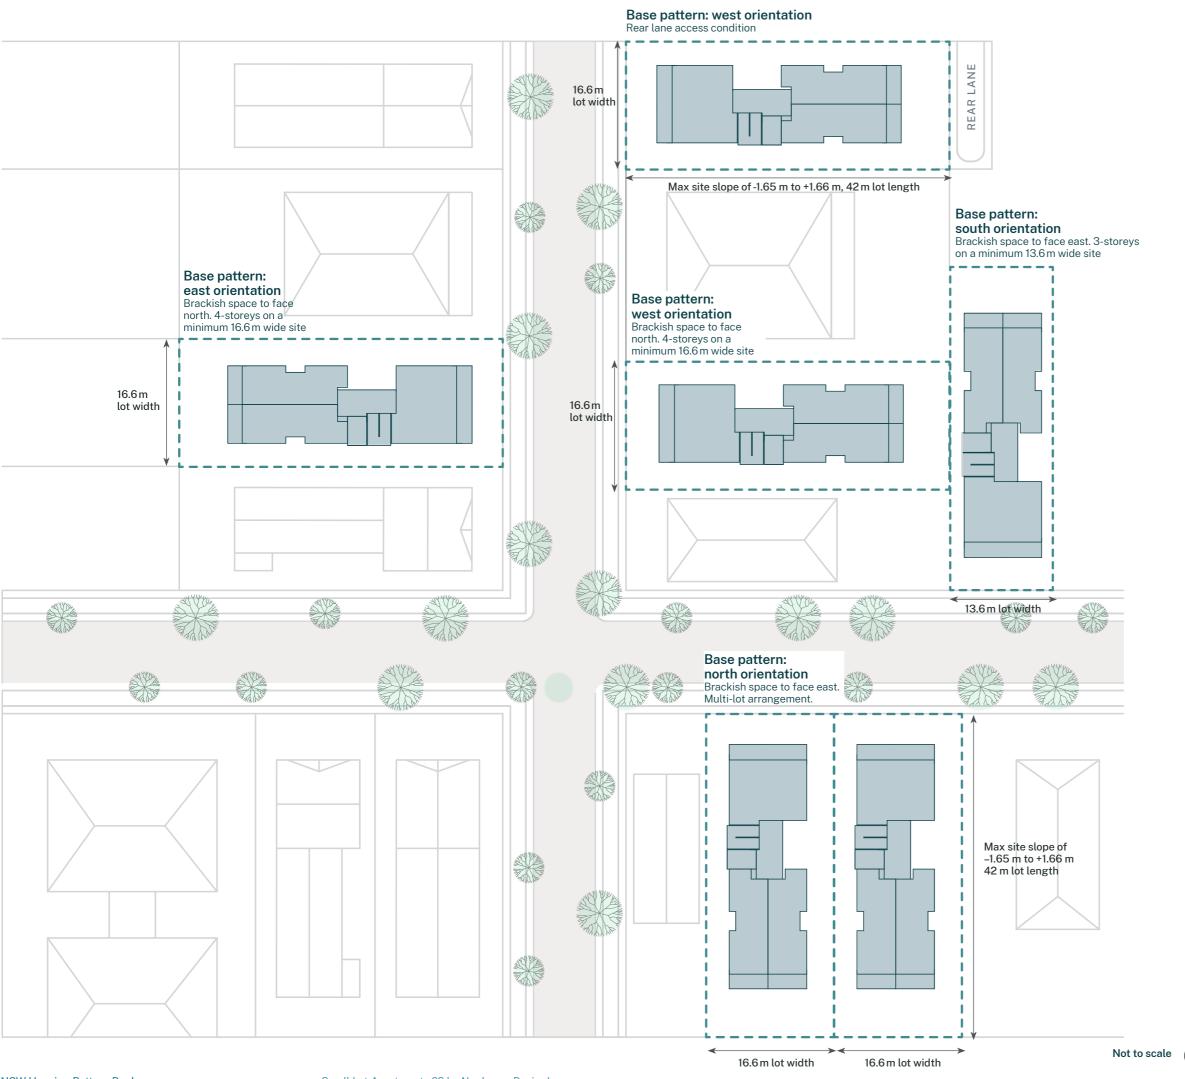

Siting

This drawing demonstrates the various urban arrangements that are available for this pattern. Pattern sites must:

- meet suitable lot type requirements (e.g. mid-block, corner, rear lane)
- meet suitable solar orientation requirements.

Refer to the planning pages of this document for further detail on the development standards of this pattern.

Find the urban arrangement that is most relevant to your site and select a suitable pattern adaptation for the site size and solar orientation.


► Refer to A-200 series for siting variants

Urban arrangements and orientation


This drawing shows the orientations and block types that can use the pattern. It also indicates what a replicated pattern would look like across an urban block.

Solar orientation


Orientations where the pattern will achieve appropriate solar compliance:

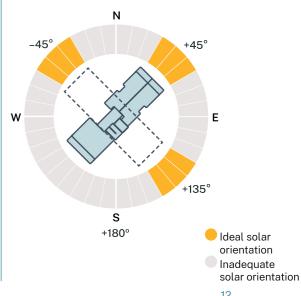


Ground floor 42 m long, 13.6 –16.6 m wide

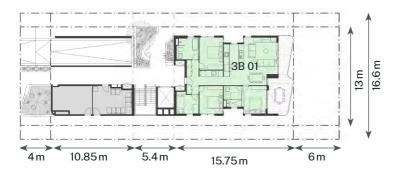

Ground floor 47 m long, 13.6–16.6 m wide

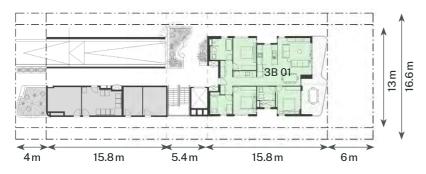


Ground floor 52m long, 13.6–16.6 m wide

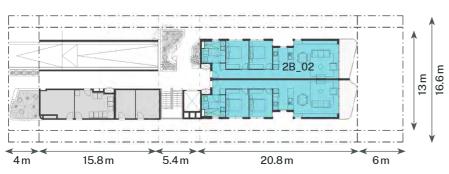


Typical floor 42 m long adaptation




Typical floor 47 m long adaptation

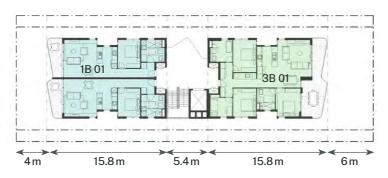


Typical floor 52 m long adaptation

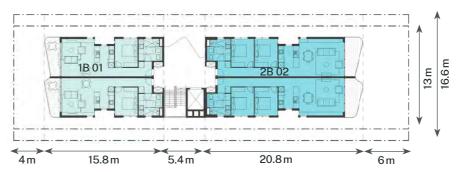

Variable side setback: 3-storeys on a minimum 13.6 m-wide lot with 1.5 m side setback, or 4-storeys on a minimum 16.6 m-wide lot with 3 m side setback

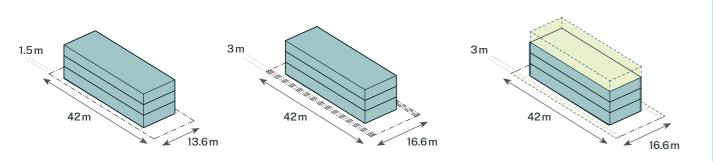

Variable site length: 3-or 4-storeys between 42-5 m.setback

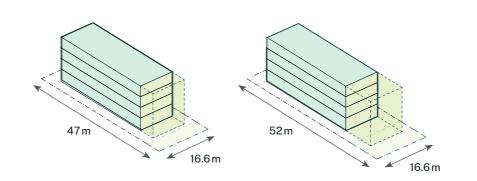

Pattern adaptations

Lot size and minimum setbacks

These plans demonstrate the various lot size adaptations that are available for this pattern. Pattern sites must:

- meet minimum lot width, lot depth and total minimum lot area
- meet minimum setbacks (e.g. front, side, rear).

Refer to the planning pages of this document for further detail on the development standards of this pattern.

Analyse the drawing to find the most relevant example for your site, which shows required lot sizes and setbacks. Using this guidance, refer to the site plan to begin adaptation to your site.

► Refer to A-200 series for pattern adaptations

- Studio
- One bedroom
- Two bedroom
- Three bedroom

Site dimensions



Not to scale



Country

Project's colour scheme is informed by the Country where the project is situated.

The intent is that each strata is read as a uniform coloured block. Where a finish is part of the base, it should match the base colour material i.e. brick selection, mortar joints, metalwork (including window frames), paintwork etc. Where a finish is part of the 'upper', it should similarly be coloured to match the lighter tone, with the exception of metalwork which should be consistent across both base and upper.

How to use

Find the local colours of Country and adapt the colour palette according to the strategy as shown. NSW Government's eSPADE soil map index comprises a statewide dataset of soil profiles, freely availble to view.

Upper

Levels 1–3 materiality employs lighter tone of Country colour, with the exception of metalwork

Base

Ground floor materiality employs darker tone of Country colour. There should be an approximate colour difference of 50% between base and upper material. **NSW Housing Pattern Book**



Brick palette



WF1-Brick walls Face brick -darker base Colour-matched mortar



WF3-Concrete Planter beds, lift core, slab edges base Paint finish - earthy red colour



Aluminium powdercoat finish-dark red (match to window framing)



WF2-Brick walls Face brick-lighter top Colour-matched mortar



WF4-Concrete Slab edges upper levels Paint finish-light earth colour

CF1-Soffit lining-Brackish space

CFC sheet

Paint finish-white



MW1-Metalwork Aluminium powdercoat finish-dark red (match to window framing)





Paint finish-white



Compressed fibre cement palette



WF1-Brick walls Face brick-darker base



WF3-Concrete Planter beds, lift core, slab edges base Paint finish - earthy red colour



CF1-Soffit lining-Brackish space CFC sheet

WF2-Brick walls

Face brick-lighter top

Colour-matched mortar



Material summary

Material selections

The patterns are available in a variety of material finishes, allowing flexibility to suit both user preferences and the unique character of each location. When selecting a material palette from these variants, consider how it complements the existing streetscape.

► Refer to A-380 series for material palette information

How geology informs materiality

The building is designed as having a 'base' (ground) and 'upper' (L1 and above). The 'base' and 'upper' stratas should be darker and lighter tones of the primary colour respectively, achieving a noticeable difference between the two.

Pattern selections

Using this guide, users can map how this pattern will be adapted to suit the specific site and meet the needs of future occupants.

Use this page to:

- Confirm the site meets the lot type, minimum frontage and area requirements of this pattern.
- Consider the parking adaptations and ground floor layouts.
- Consider the height adaptations.
- Review the lot features such as orientation and slope to inform which pattern adaptations need to be used.
- Consider the dwelling mix.
- Consider the material palette and character options available.

Refer to instructions for designers pages for the next steps, including how to use this page as part of your application.

Siting location	Lot size	Adapt for suitability	Lot features	Building character
Lot type	Minimum lot size 1.5 m setback	Storeys	Lot type select one	Material palette select one
LMR housing area site	13.6 m (w) x 42 m (l)	3 storeys	Standard mid-block	Material palette 1
571 m² (min) lot area 13.6 m (min) lot width	13.6 m (w) x 47 m (l)	4 storeys	Parallel street or	Variable coloured brick Material palette 2
*Allows ABCB livable design standard	13.6 m (w) x 52 m (l)	Apartment yield & mix	laneway mid-block	☐ Material palette 2 Variable coloured CFC
TOD housing area site 571 m² (min) lot area	Minimum lot size 3 m setback	Studio	Solar orientation of brackish space	
13.6 m (min) lot width	16.6 m (w) x 42 m (l)	1 bedroom	☐ North-east	
*Allows ABCB livable design standard	16.6 m (w) x 47 m (l)	2 bedroom	☐ South-west	
	16.6 m (w) x 52 m (l)	3 bedroom	☐ North-west	
	Minimum setbacks 4 m front setback	No more than 75% of a single type	Site slope select one	
	1.5 m side setback <u>or</u>	Parking	0 – 1.66 m upslope 42 m (l) site	
	3 m side setback	Basement	0 –1.65 m downslope	
	6 m parallel street or laneway setback 6 m rear setback	*Existing site slope allows for basement	42 m (l) site	
	— Officer Setback	Substation		
		☐ Kiosk substation required		
		☐ No substation required		
			-	

The site location and available adaptations are described in the pattern adaptations and site plan pages.

To understand the extent of options available, refer to the technical drawings section and review the base pattern plans and available adaptations.

To understand the how to adapt the patterns height, apartment yield and mix, parking and substation requirements, refer to in the technical drawings.

Lot adaptations to suit different lot types, orientations and are described on pattern adaptationslocation requirements pages and in the technical drawings. Refer to the material palette guidance pages and included illustrative images for further information.

NSW Housing Pattern Book Small Lot Apartments 02 by Nguluway DesignInc

Technical considerations

Engaging a design team

To prepare a mid-rise pattern for a site-specific planning application, the user must engage a design team to adapt the pattern drawings and prepare information required for the application. The team may include architects, engineers, quantity surveyors and other specialists.

It is the responsibility of the developer to investigate and understand the legal, financial, environmental and planning matters and risks of undertaking pattern book development on a chosen site.

Units and measurement

The pattern designs have been drafted to standard drawing scales. Site measurements are generally identified as a minimum, allowing users to make site specific adjustments. Should discrepancies exist, refer to the development standards table. Measurements for sites have been rounded to the nearest 0.1 m. Areas have been rounded up or down to the nearest 5 m².

NCC compliance

The mid-rise patterns are capable of compliance with the National Construction Code (NCC) 2022 subject to final technical specifications and details. Additional compliance measures and reporting are required for Class 2 under the Design and Building Practitioners Act 2020. For Class 2 development, the proponent is required to engage a practitioner registered with the NSW Design and Building Practitioners (DBP) Scheme.

Universal design

Mid-rise pattern book dwellings must comply with the Australian Building Codes Board (ABCB) Livable Housing Design Standard, which has been adapted from the 'silver' level requirements of the Livable Housing Association (LHA) Livable Housing Design Guidelines.

Site slope

The pattern designs can be modified to suit gently sloping sites. The scope for this is documented in Requirements and Adaptations > Siting and Pattern adaptations.

As patterns are adjusted to meet specific site conditions, design considerations include:

- maintaining paths of travel to front doors according to the ABCB Livable Housing Design Standard
- potential for and locations of retaining walls
- stormwater management and drainage systems.
- ► Refer to A-200 series for site slope adaptations

Driveways and crossings

The location of the driveway and driveway crossing is shown on the plans. Proponents must ensure the design meets the requirements of relevant Australian Standards.

Driveways should not be affected by existing structures such as street trees, earth mounds, bus shelters, power poles or other physical features. Removal of such features may be permitted subject to council approval.

A description of parking and traffic approach and assumptions for the development of pattern designs is included in the technical guide to support the further design development of your pattern project for a specific site.

Construction and materials

The construction system for pattern designs provides efficient and coordinated planning, aligning load paths, wet areas and service risers where practical. Specific materials have been selected for the external elevations and character as shown on the materials pages.

Structural design

The pattern designs have been developed with input from structural engineers. A description of their assumptions and advice for the further development of a pattern for a specific site is included in Technical summary.

Facade design

The facade design of the mid-rise patterns designs have been developed with input from specialist consultants. A description of their assumptions and advice for the further development of a pattern for a specific site is included in the technical guide.

Entries

The location of entries into the building, into individual apartments and onto balconies, roof terraces and the like are all set by the pattern and cannot be changed.

Interior layouts

Any changes to apartment interiors must be declared in the design verification statement and cannot exceed the flexibility listed above. The position of all rooms must be in accordance with the apartment layouts provided in the pattern, this can include mirrored layouts where the pattern provides for this.

Fixture and fittings may be selected and positioned at the discretion of the applicant, except for robes and storage sizes and bathroom dimensions and clearances, as these are set by the pattern. Specification of bathroom fixtures (toilets, baths, sinks) are at discretion of the applicant provided that there is no reduction in clearances, including but not limited to those associated with liveability and adaptable apartments.

Services provision

The pattern designs have been developed with input from specialist consultants. A description for each of these disciplines and their assumptions is included in the technical guide to support the development of your pattern project for a specific site.

Fire performance

Fire risks have been discussed with Fire and Rescue NSW (FRNSW). Examples of typical fire performance solutions have been developed to assist project teams in completing fire performance documentation for their development. To ensure the safety and compliance of the development, seek expert advice from a fire consultant and consult with FRNSW as required by relevant legislation.

Services assumptions		
Mechanical	1 condenser/apartment; exhausts avoid fire compartments	
Electrical	Load <1000 kVA; photovoltaics (PV) roof allocation 20–100%; switchroom 20 m ²	
Hydraulic	2000 L grease traps; dual pump sets; risers near fixtures	
Fire	1–2 hydrants based on area; 215 m² tank room; full smoke detection	
Civil	On-site stormwater detention (OSD) 0–470 m ³ /ha; 10 kL rainwater tanks; 3.5 mm/m ² /day irrigation	
Rooftop condensers and risers	Per apartment	
Substations	External kiosk	
Kitchen / bathroom	Risers stacked for efficiency All electric appliances Clearances retained	
Fire systems	Coordinated with spatial layouts	
Rainwater tanks	Upstream or combined with OSD	

 Refer to Mid-rise pattern book technical guide > Services for details

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Waste

A consistent approach to waste management has been applied to the pattern to support practical and adaptable waste solutions across NSW. The approach has been derived from the NSW Environment Protection Authority (EPA) Better practice guide for resource recovery in residential developments and relevant legislation. It has also been informed by a review of 30 council waste guidelines, and spatial assessment of kerbside, wheelin wheel-out (WIWO) and on-site collection options across all patterns.

Program objectives

The pattern approach to waste management aims to:

- enable consistent, affordable and practical waste management solutions that can suit unknown future sites
- align with the NSW EPA Better practice guide and relevant legislation
- provide a clear planning pathway for waste collection and storage planning in the patterns that can be applied statewide to address variability in council requirements.

Assumptions

The waste design for patterns assumes that:

- Waste collection is council-managed (not private) and there is a weekly pick-up for all streams.
- Low-tech solutions and manual manoeuvring are allowed for as building managers may not be available to operate complex equipment. If equipment (for example bin lifts, compactors) is needed for large lots, this is shown on the drawings.
- Allowance has been made for general, recycling and organic waste streams, as waste consolidation may be impractical for small-scale developments due to spatial and operational constraints. Bulky waste storage has also been provided.
- Basement waste collection has been limited, due to spatial constraints on small lot sites.
- Waste generation estimates and bin room sizing are designed to accommodate weekly and fortnightly collection.


Collection method

Kerbside: all streams weekly


Seek advice

Refer to the NSW EPA Better practice guide early, with advice from a waste consultant as required.

Basement

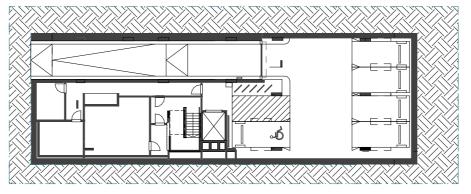

Ground floor plan - basement parking

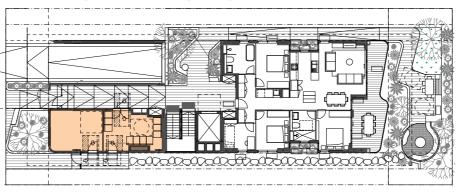

Metrics (assumptions)

Waste generation rates per unit

Studio/1-bed 80 L general

> 80 L recycling 25L organics/week

2-bed 100 L general

> 100 L recycling 25L organics/week

3-bed 120 L general

120 L recycling

50L organics/week

Bulky waste

Up to 40 dwellings $10 \, \text{m}^2$

Per 10 additional +2 m² dwellings

Problem/textile Optional 1 m²

Waste generation rates for the base pattern

Type 1 (11 units):

waste

1020 L general 1020 L recycling

325 L organics/week

Nominal bin room sizing

 $24 \, \mathrm{m}^2$

Kerbside collection requirements

Weekly collection of all streams

Sizing for the base pattern

Maximum number of 240-L 9 bins to be presented at kerbside every week

Waste

Parking and traffic

Approach

There is one option available for off-street parking in this pattern: a basement parking arrangement. The basement parking arrangement complies with Australian Standards. Basements can be replanned as required but must not alter other pattern requirements outlined in this document.

Objectives

- Ensure compliance with Australian Standards (AS2890 series).
- Provide spatial planning guidance for residential and service vehicle parking.
- Address site-specific constraints and public domain interfaces.
- Recommend technical solutions for restricted access scenarios.

Assumptions

- Site interfaces with public roads vary across NSW and influence design.
- Residential parking is primarily Class 1A.
- Heavy vehicle access must be forward in/forward out.
- level difference.
- Heavy vehicle parking is ideally placed on ground level, outside building structures.

Brief

- Mid-rise pattern book schemes vary in topography and planning context.
- Basement and at-grade parking options are considered.
- Designs for residential off-street parking consider:
- space dimensions
- ramp grades
- driveway access.
- Recommendations for heavy vehicle parking and service bay dimensions are shown.
- Technical solutions are provided for narrow or restricted access corridors.
- Emphasis on compliance and practical implementation across diverse site conditions.

Seek advice

Further design refinement should consider:


- updated AS2890.1 standards (pending renewal)
- integration with public domain and pedestrian pathways
- operational feasibility of vehicle priority systems.

These diagrams demonstrate pattern — Ramp designs assume a typical 3 m adaptations available for parking configurations.


> Analyse the diagrams and user requirements to find the most suitable adaptations for your development.

► Refer to A210. A311 and A-350 series for ground floor and basement plans and sections

Basement parking

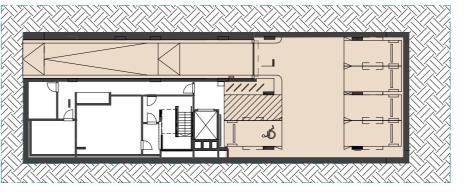

Ground floor plan - basement parking

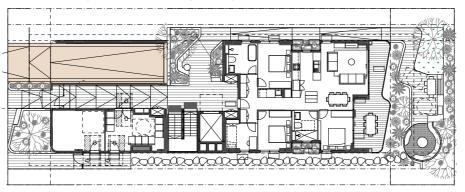

Metrics (assumptions)

Residential parking dmensions

90° angled: $5.4 \,\mathrm{m} \times 2.4 \,\mathrm{m}$ (aisle: 5.8 m or 6.1 m with obstruction)

Parallel

2.1 m width (2.4 m with obstruction). 5.9-6.3 m length

Ramp grades

2 m @ 12.5%, 11 m @ 25%, 2 m @ 12.5%

Driveway access

6 m section at 1:20 slope for waiting and pedestrian access

Access ramps accomodated

Single-width

by designs

Vehicle priority systems recommended for safe access

Small sites: traffic lights and convex mirror

Parking

NSW Housing Pattern Book

SMALL LOT APARTMENTS 02

Technical drawings



Drawing list

Drawing no.	Drawing title	Scale	Rev
A-100	Sub-cover and list of drawings		01
A-200	Designing with Country principles		01
A-201	Pattern adaptations – base pattern design concepts		01
A-202	Base pattern		01
A-202	Pattern adaptations		01
A-202	Pattern adaptations – siting and orientation		01
A-205	Solar pinwheel diagram		01
A-206	Lot size and mix variants		01
A-207	Pattern adaptations – topography		01
A-310-1	B01 plan – basement parking N/S orientation		01
A-311-1	L00 plan – basement parking N/S orientation		01
A-312	L01 plan – basement parking N/S orientation		01
A-313	L02 plan – basement parking N/S orientation		01
A-314	L03 plan – basement parking N/S orientation		01
A-315	Roof plan – basement parking N/S orientation		01
A-350	Section A-A		01
A-351	Section B-B		01
A-352	Section C-C		01
A-360-1	North elevation and adaptations		01
A-360-2	South elevation		01
A-360-3	Elevations and adaptations		01
A-370-1	Apartment plans		01
A-370-2	Apartment adaptation plans		01
A-370-3	Apartment plans		01
A-370-4	Apartment plans		01
A-380	Material palette guide		01
A-381	Materials palette		01
A-382	Materials palette		01
A-390	Rendered views 01		01
A-391	Rendered views 02		01
A-392	Rendered views 03		01
A-393	Rendered views 04		01
A-394	Rendered views 05		01
A-395	Illustrative axonometric view – key features		01
A-396	Illustrative axonometric view – adaptable elements		01

Drawing no.	Drawing title	Scale	Rev
A-400	Services diagrams		01
A-401	Structure diagrams		01
A-410	Window and door schedule		01
A-411	Key facade element types		01
A-420	Key detail plans		01
A-423	Key details sections		01
A-430	Area calculations		01
A-431	Area calculations		01
A-434	Area calculations		01
A-435	Area calculations		01
A-500	Solar access diagrams		01
A-510	Cross-ventilation		01
A-520	Wet area drawings		01
A-521	Wet area drawings		01
A-522	Wet area drawings		01
A-530	Wall types		01
A-540	Maintenance/access diagram		01

LOT WIDTH ADAPTATION

The base pattern can be adapted to site widths ranging from 13.6m to 16.6m. If the width is:

Between 13.6m to 16.5m: Only 3 storeys is permissible, with a minimum 1.5m side setback.

Above 16.6m: 4 storeys is permissible, with a minimum 3m side setback.

Note: For sites smaller than the base pattern it is noted that the FSR/GFA maximum may not be achievable for both variations of width and lengths.


LOT LENGTH ADAPTATION

The base pattern can be adapted to site lengths ranging from 42m to 52m, variations in building length are shown in the diagram below.

If the site width is:

Shorter than the base pattern: Car park basements are not recommended and only on-street parking with a two studio configuration is preferred. Should a substation be required, this would be embedded into the building in the form of a kiosk substation located in the front landscaped zone.

Longer than the base pattern: Apartment configurations can be varied to increase yield and size.

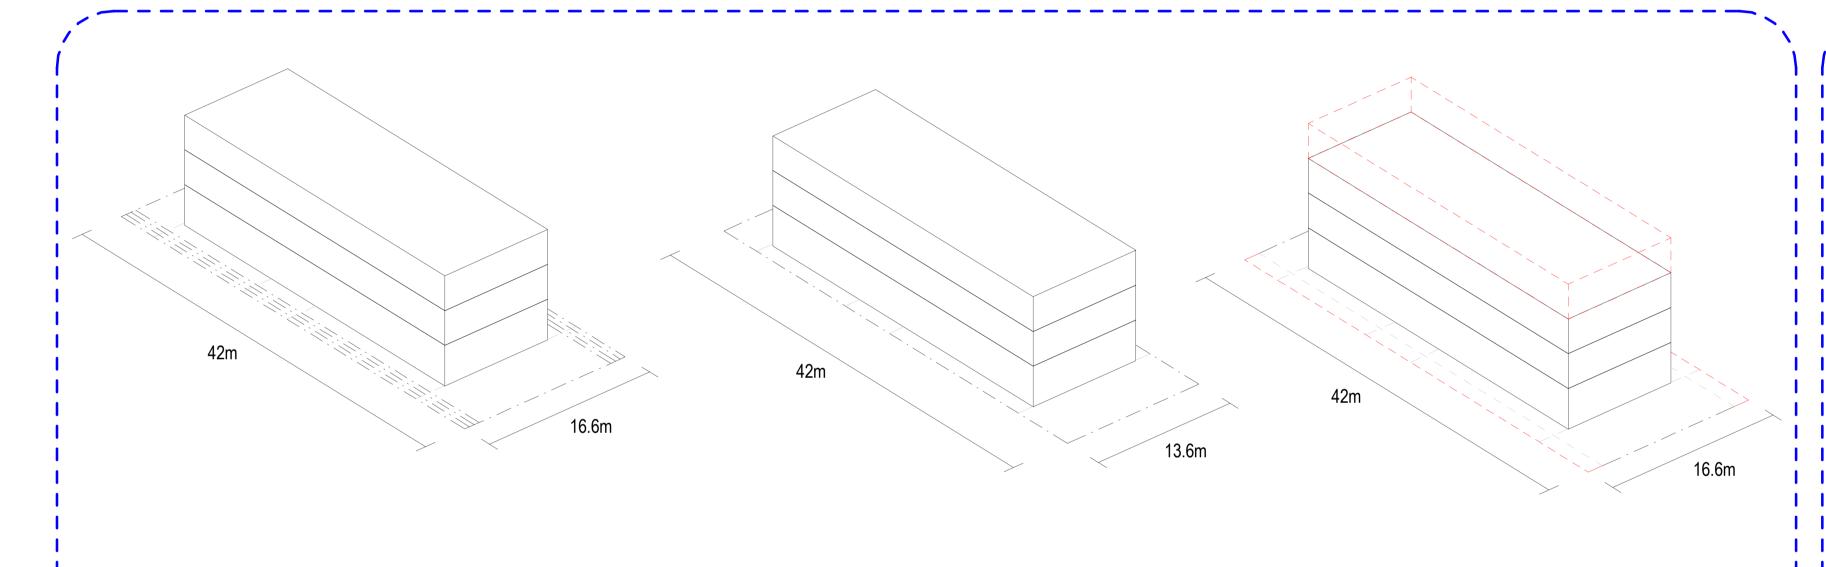

47m 52m

The building does not widen, instead setbacks increase as follows:

 Site width
 Minimum side setback

 13.6m
 1.5m

 14.6m
 2.0m

 15.6m
 2.5m

 16.6m
 3.0m

3 storeys are permitted on minimum site width of 13.6m

4 storeys are permitted on minimum site width of 16.6m

Length adaptations are as follows:

Site length	Building length
42m	32m
47m	37m
52m	42m

NSW HOUSING PATTERN BOOK



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Rev	Date	Description
Rev 1	Nov 2025	Pattern Book Issue


_	NGULUWAY DesignInc
_	Gadigal Country Level 12, 126 Phillip Street, Sydney NSW 2000 +61 2 8905 7100 Reception@Nguluway.designinc.com.au


Pattern Code	SLA02
Name	Small Lot Apartments 02
	by Nguluway DesignInc

Drawing No.	A-201
Name	PATTERN ADAPTATIONS – BASE PATTERN DESIGN CONCEPTS


Scale NTS


Adaptations

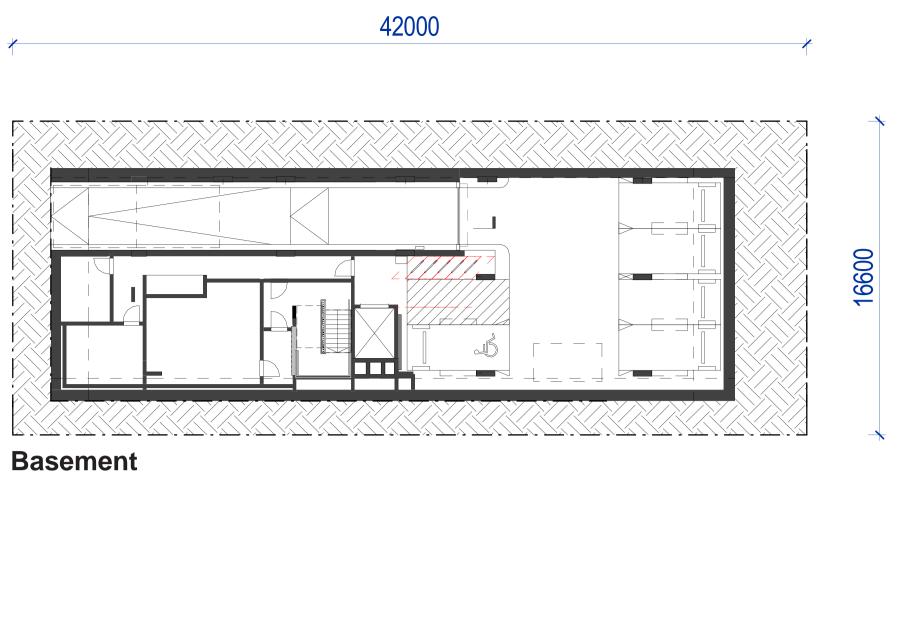


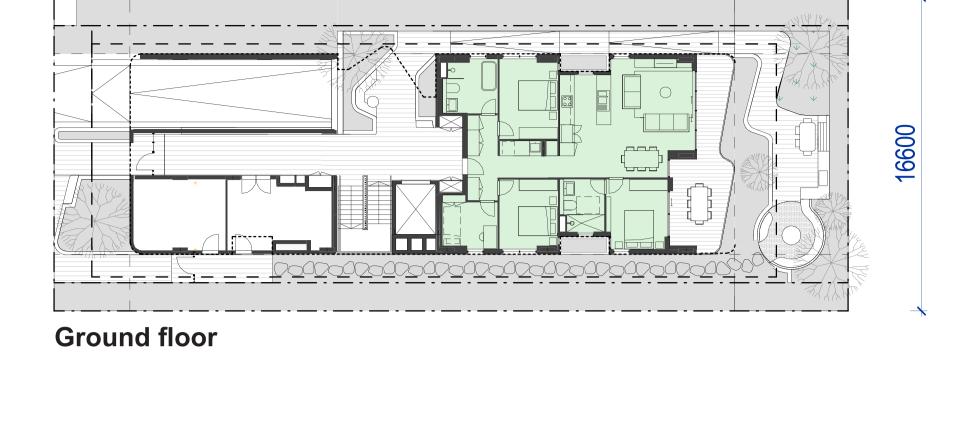


42000

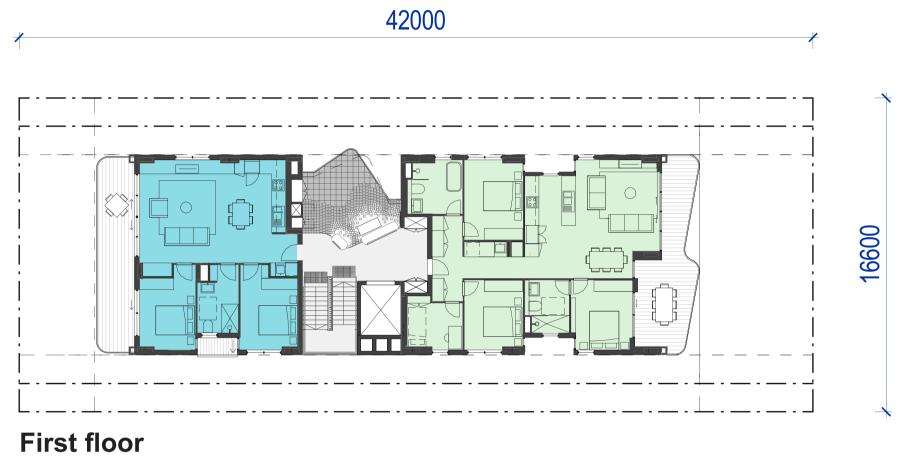

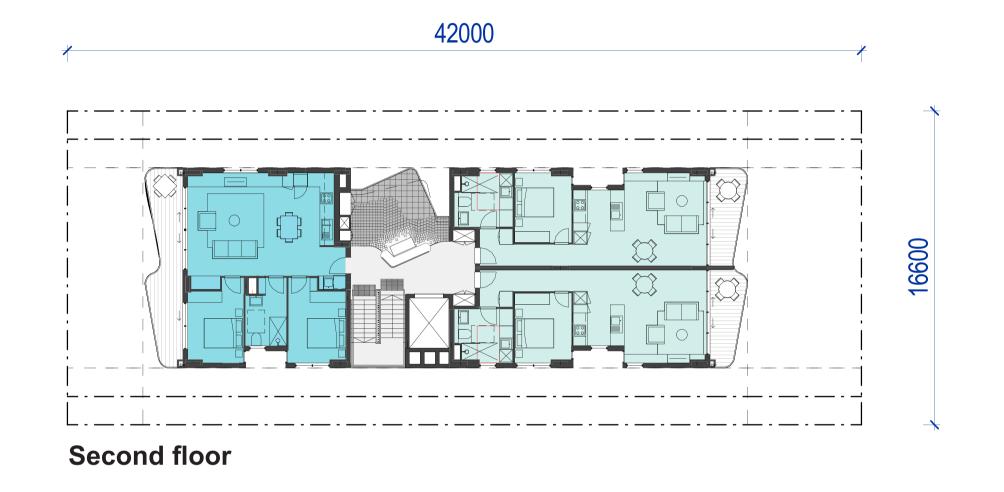

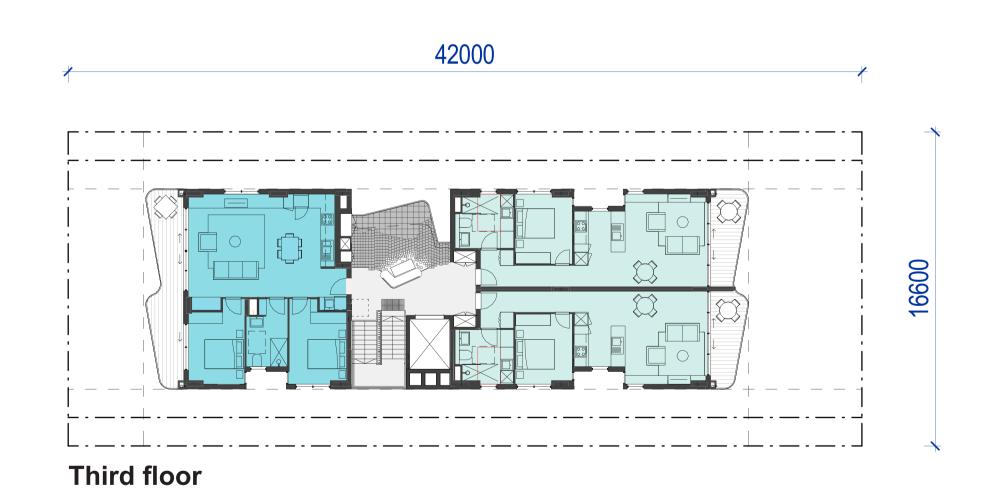

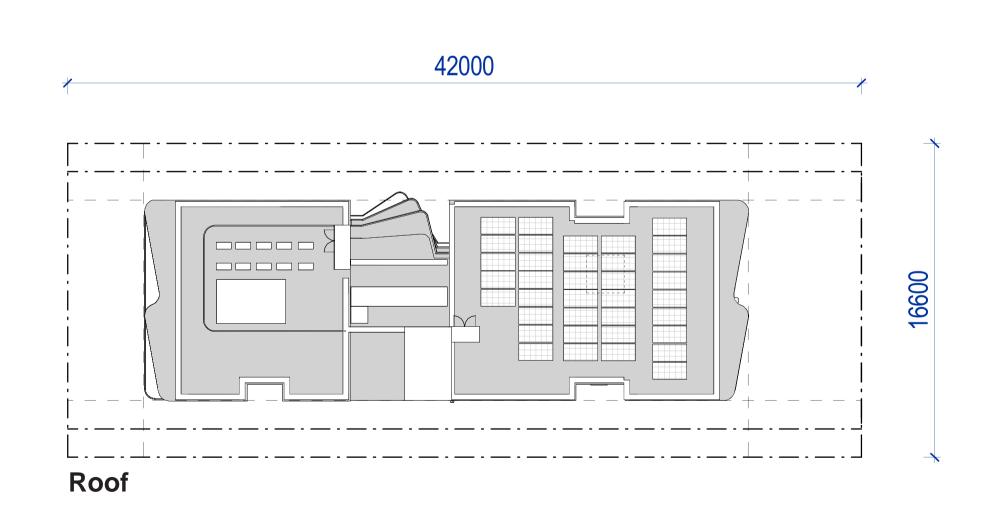

BASE PATTERN METRICS

Site dimensions & setbacks:

Minimum lot area: 697m²
Minimum lot width: 16.6m
Minimum lot length: 42m
Minimum front setbacks: 4m
Minimum side setbacks: 3m
Minimum rear setbacks: 6m

Height & storeys

Maximum building height: 17.5m

Storeys: 4

GFA: 873m2 FSR:1.25:1

GFA & FSR

Basement

- Parking for cars and bicycles
- Plant rooms & services

Ground floor

- Front, central and rear communal 'brackish' spaces
- 13-bed

First floor

- 12-bed
- 1 3-bed
- Central communal 'brackish' spaces

Second floor

- 1 2-bed
- 2 1-bed
- Central communal 'brackish' spaces

Third floor

- 12-bed
- 2 1-bed
- Central communal 'brackish' spaces

A-202

NTS

BASE PATTERN

Roof

Services

NSW HOUSING PATTERN BOOK



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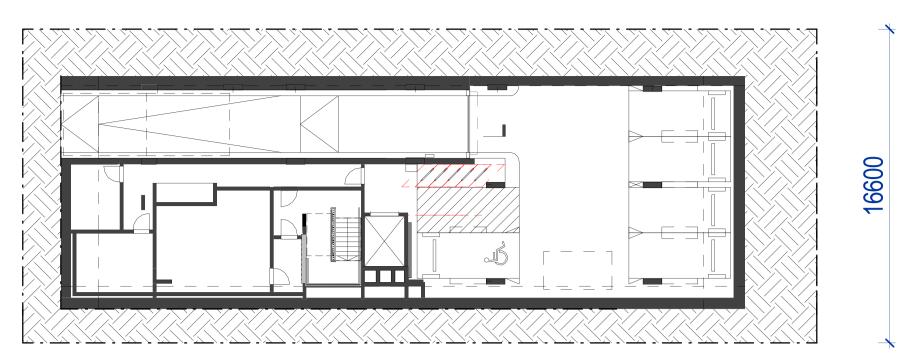
Rev	Date	Description	
Rev 1	Nov 2025	Pattern Book Issue	



Name	Small Lot Apartments 02
	by Nguluway DesignInc

Pattern Code **SLA02**


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2	Name
	Scale




Basement



Ground floor

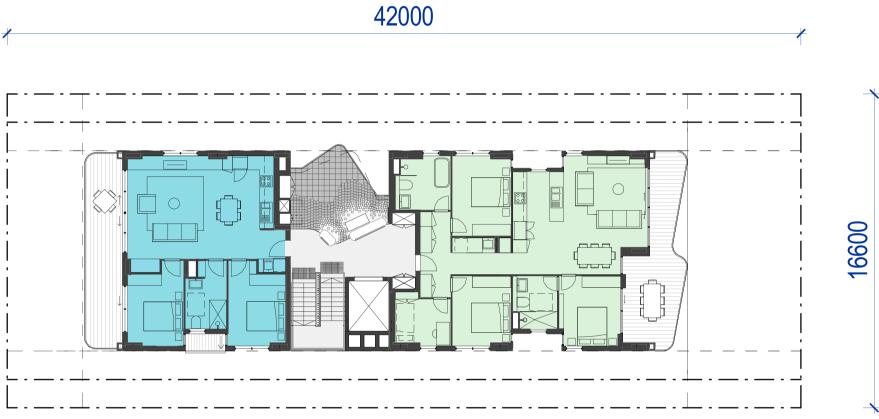


First floor

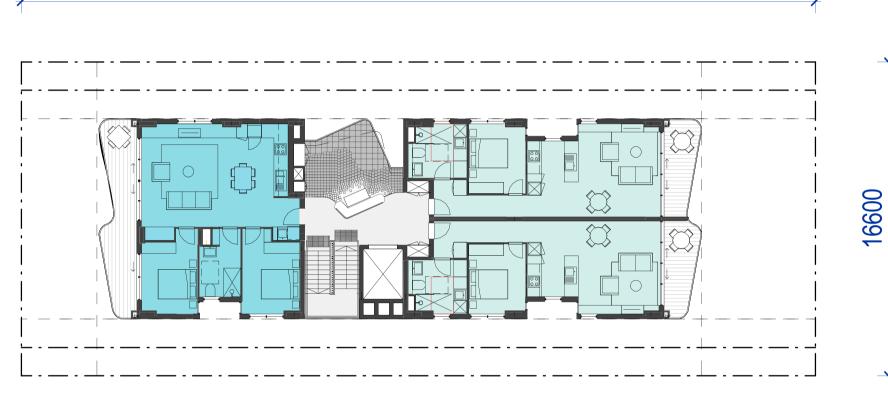

42000

Second floor

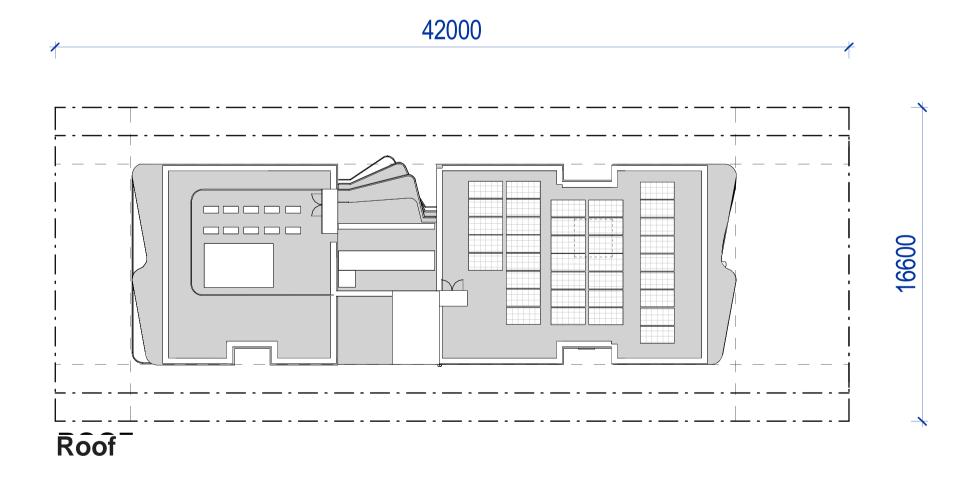



ADAPTATION METRICS

Site dimensions & setbacks:

Minimum lot area: 697m² Minimum lot width: 16.6m Minimum lot length: 42m Minimum front setbacks: 4m Minimum side setbacks: 3m Minimum rear setbacks: 6m

Height & storeys

Maximum building height: 17.5m

Storeys: 3

GFA & FSR

GFA: 642m2 FSR:0.92:1

Basement

- Parking for cars and bicycles
- Plant rooms & services

Ground floor

- Front, central and rear communal 'brackish' spaces
- 1 3-bed

First floor

- 1 2-bed
- 13-bed
- Central communal 'brackish' spaces

Second floor

- 1 2-bed
- 2 1-bed
- Central communal 'brackish' spaces

Roof

Services





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	Name
60	

Pattern Code

Small Lot Apartments 02 by Nguluway DesignInc

SLA02


Drawing No.

Name

BASE PATTERN

A-203

NTS Scale

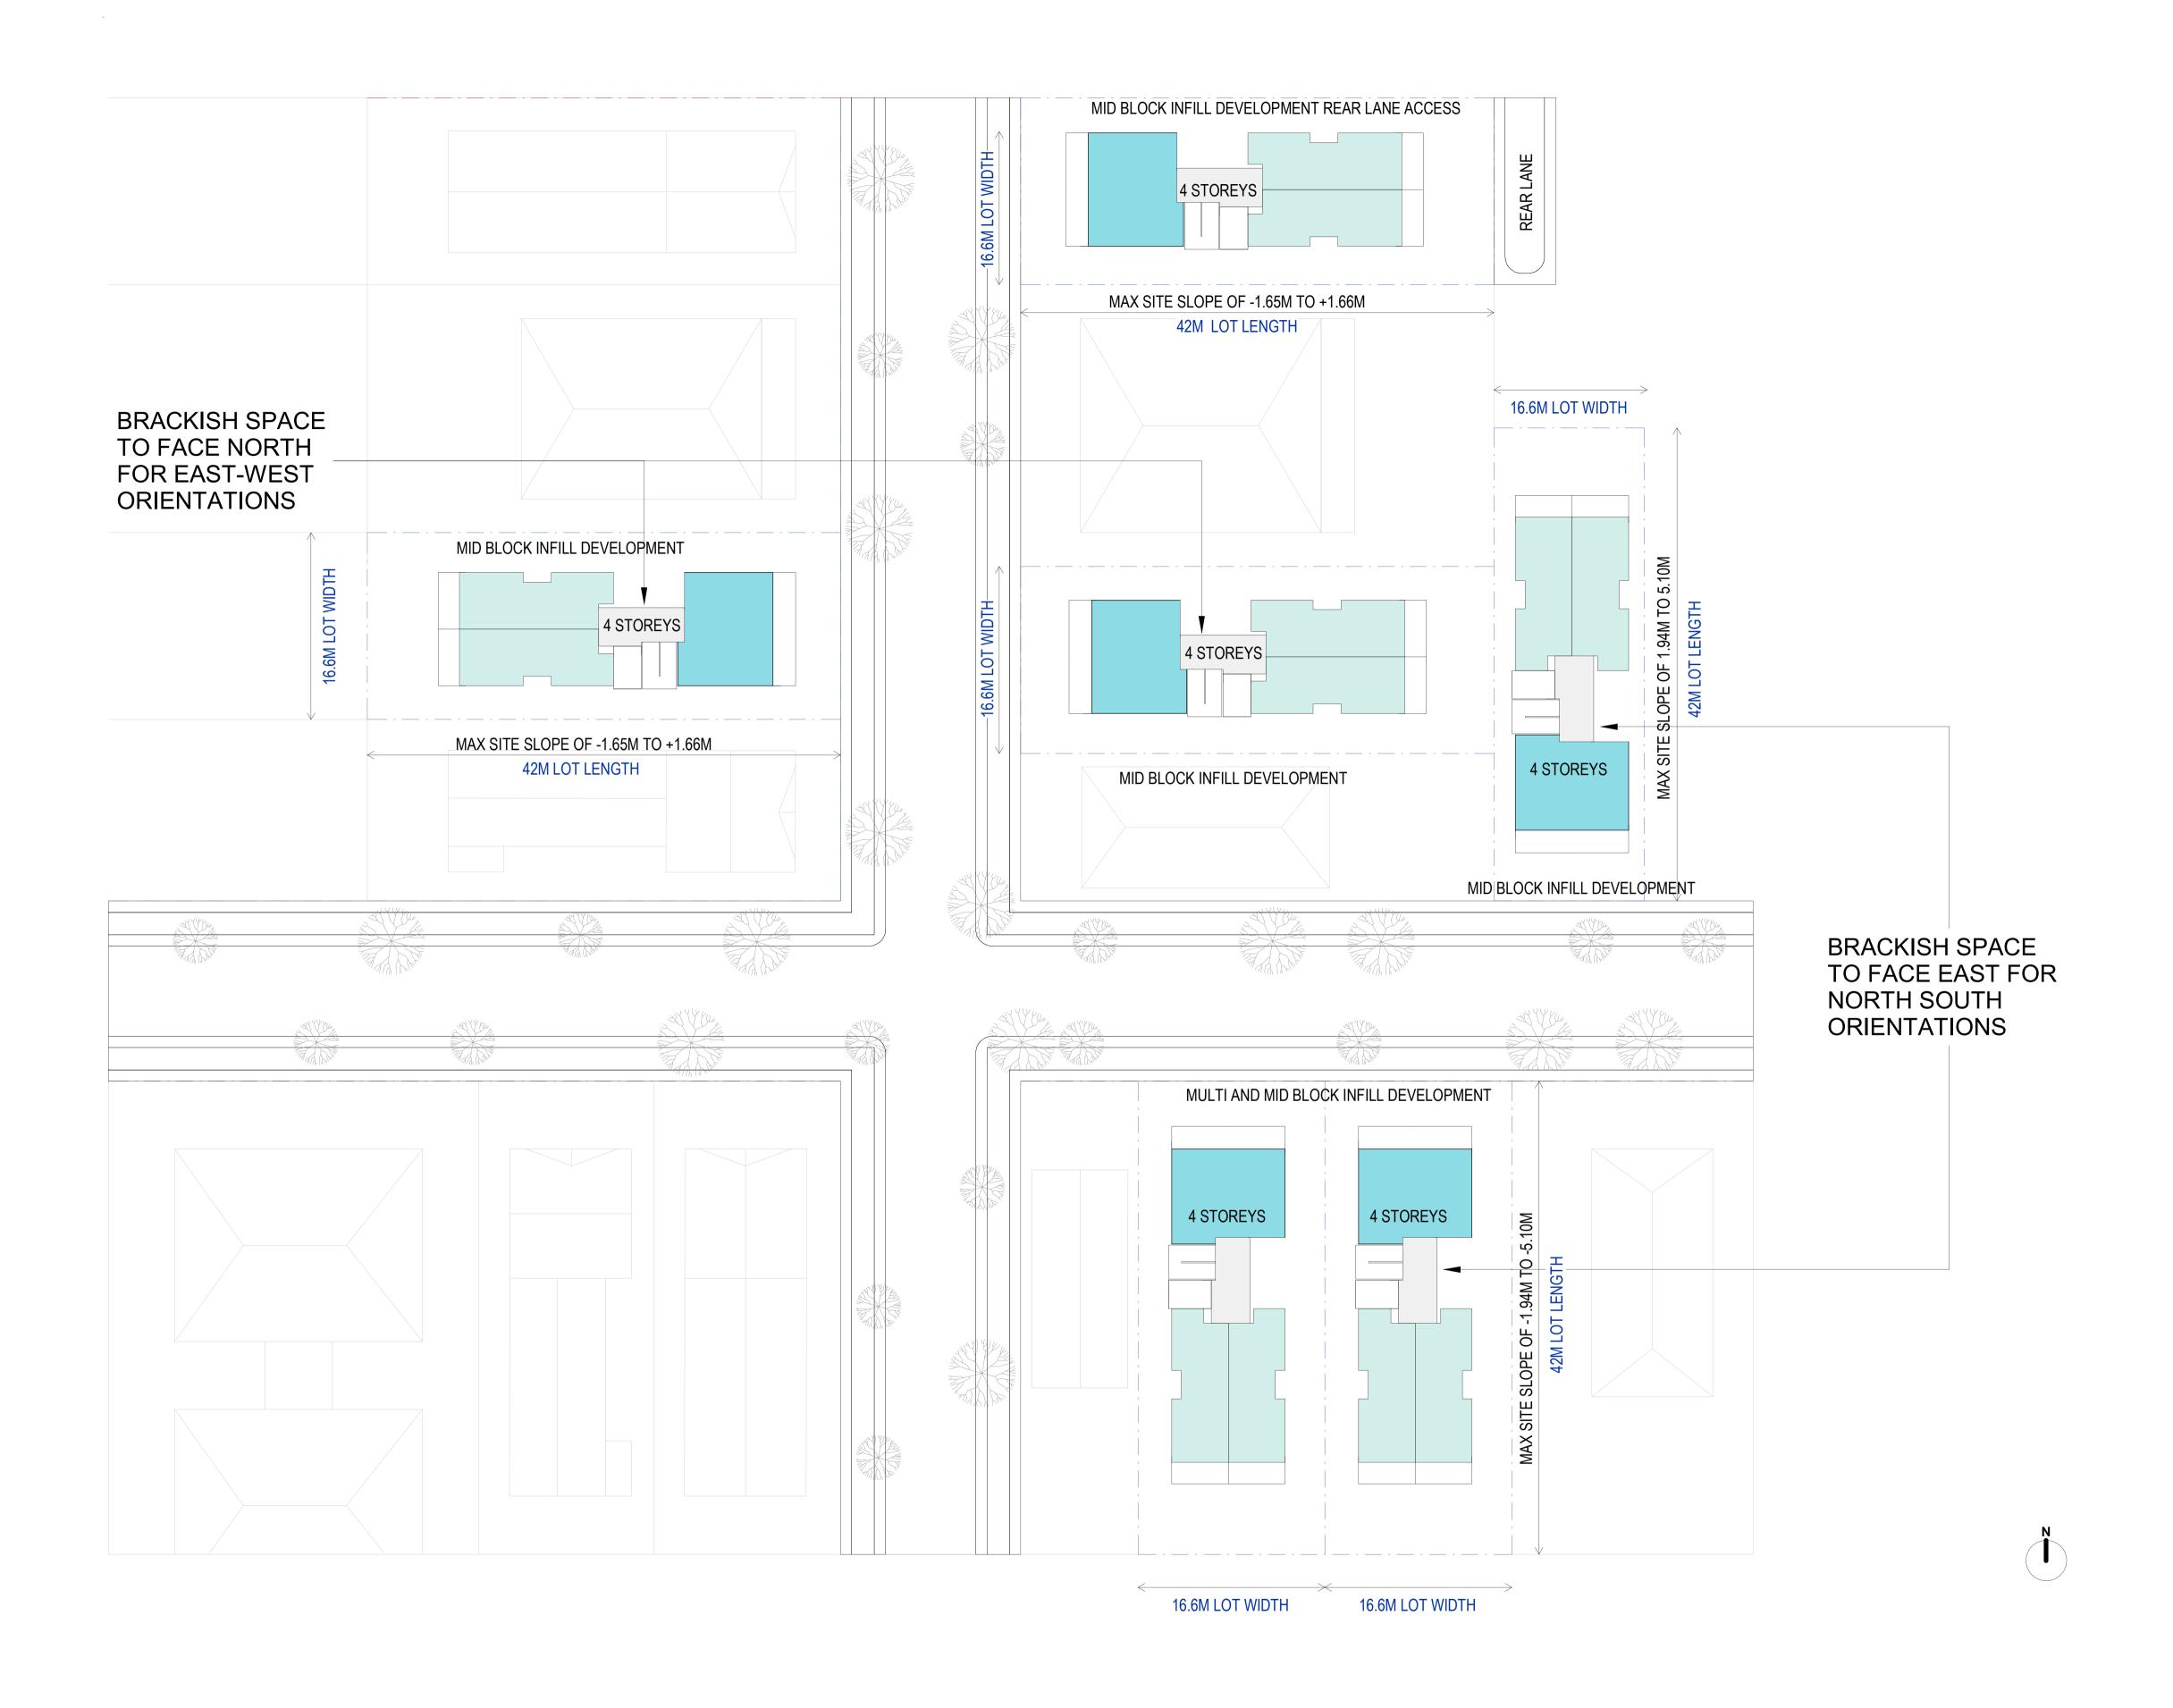

SITING AND ORIENTATION

Possible adaptations of the base pattern to different site orientations are show on the left. The design of the base pattern with its ventilation notches, communal spaces, window and balcony orientations allow for adaptation to varying arrangements of neighbouring buildings without affecting quality and amenity offered. Depending on the orientation of the site, the central brackish space would be adapted to face either north or east; this is to maximise solar access to the space.

NSW HOUSING PATTERN BOOK



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	Rev	Date	Description	
	Rev 1	Nov 2025	Pattern Book Issue	
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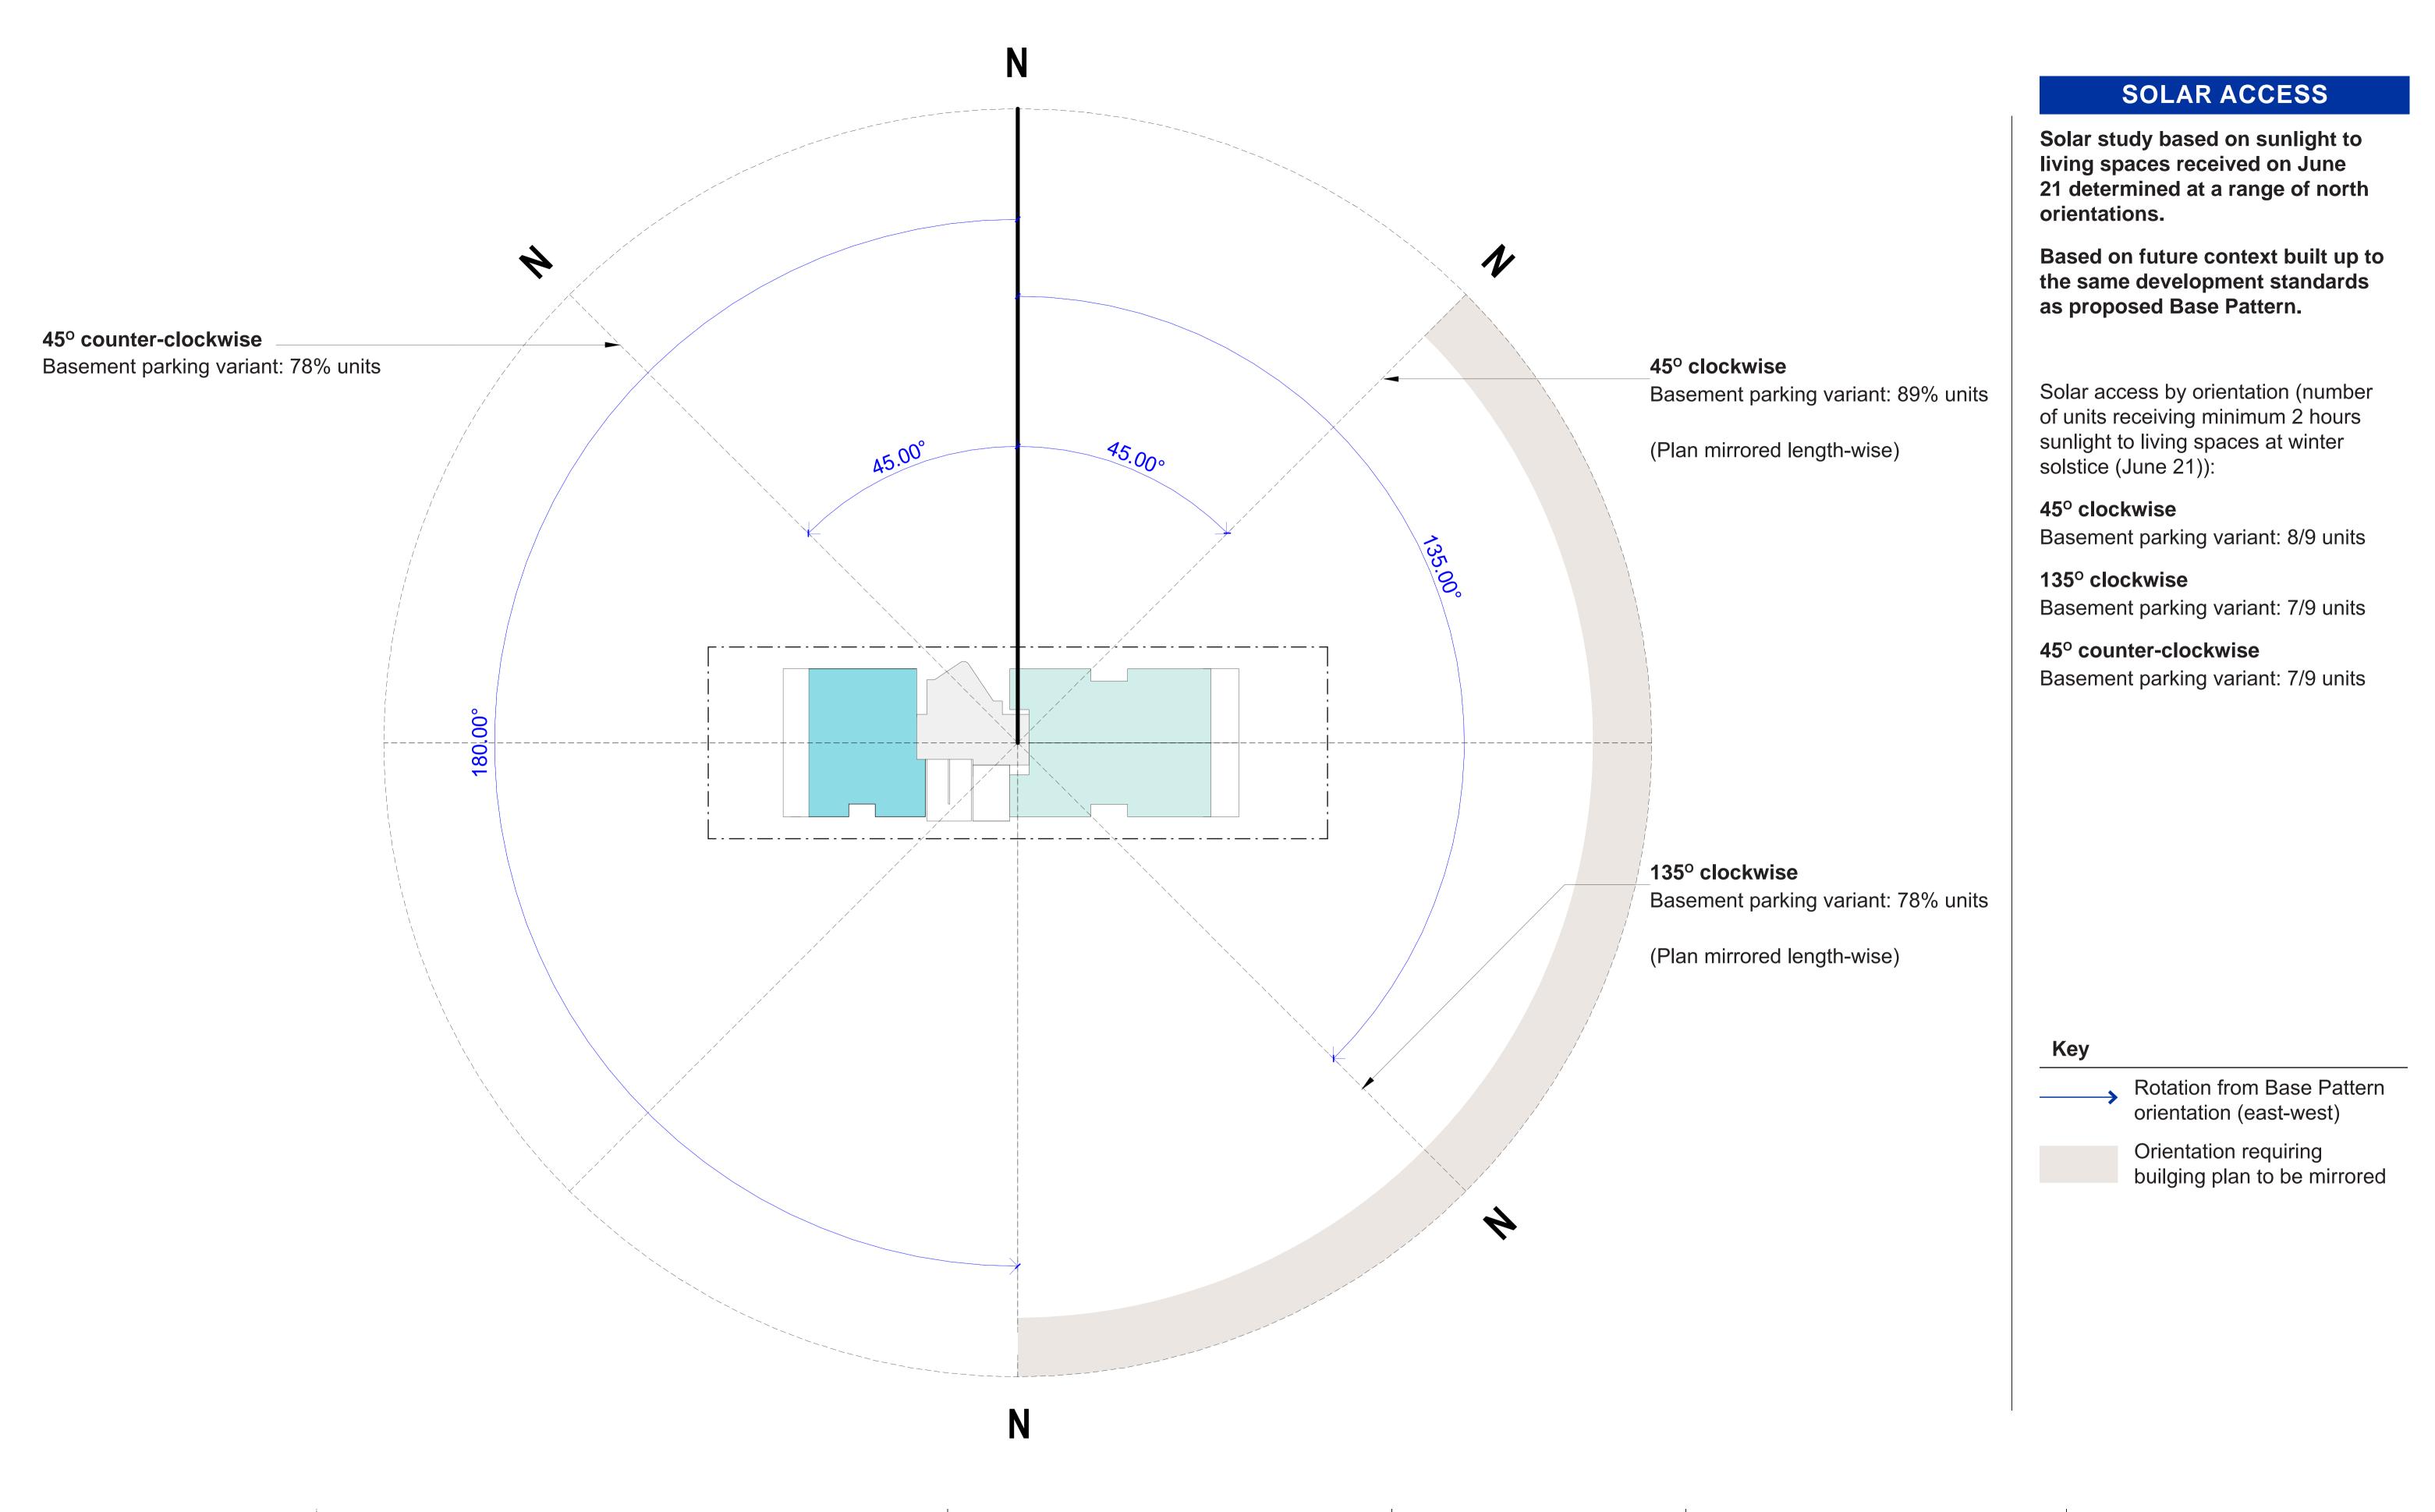
NGU	LUWAY DesignInc
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Cathryn Drew-Bredin

Pattern Code	SLA02
Name	Small Lot Apartments 02
	by Nguluway DesignInc

rawing No.	A-204
lame	PATTERN ADAPTATIONS - SITING AND ORIENTATION

Scale 1:300 @ A1







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Date	Description	
Nov 2025	Pattern Book Issue	
		'

NGU	LUWAY DesignInd
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+61 2 8905 7100	Reception@Nguluway.designinc.com.au

Pattern Code	SLA02
Name	Small Lot Apartments 02
	by Nguluway DesignInc

Drawing No.	A-205
Name	SOLAR DIAGRAM

Scale NTS

BASE PATTERN: 42M SITE LENGTH 42000 BASEMENT OOGE OROND FROM GROUND FLOOR GROUND FLOOR




GFA		GFA		UNIT MIX	
RESIDENTIAL GFA		COMMUNAL & W	VASTE ROOM	STUDIO	0 - 00.0%
GROUND	118m ²	GROUND	71m ²	1B	4 - 44.4%
LEVEL 01	197m ²	LEVEL 01	25m ²	2B	3 - 33.3%
LEVEL 02	206m ²	LEVEL 02	25m ²	3B	2 - 22.2%
LEVEL 03	206m ²	LEVEL 03	25m ²		
ROOF	N/A	ROOF	N/A	TOTAL	9
TOTAL	727m ²	TOTAL	146m ²		

697.2m²

873m²

1.25:1

PATTERN VARIANT: 47M SITE LENGTH

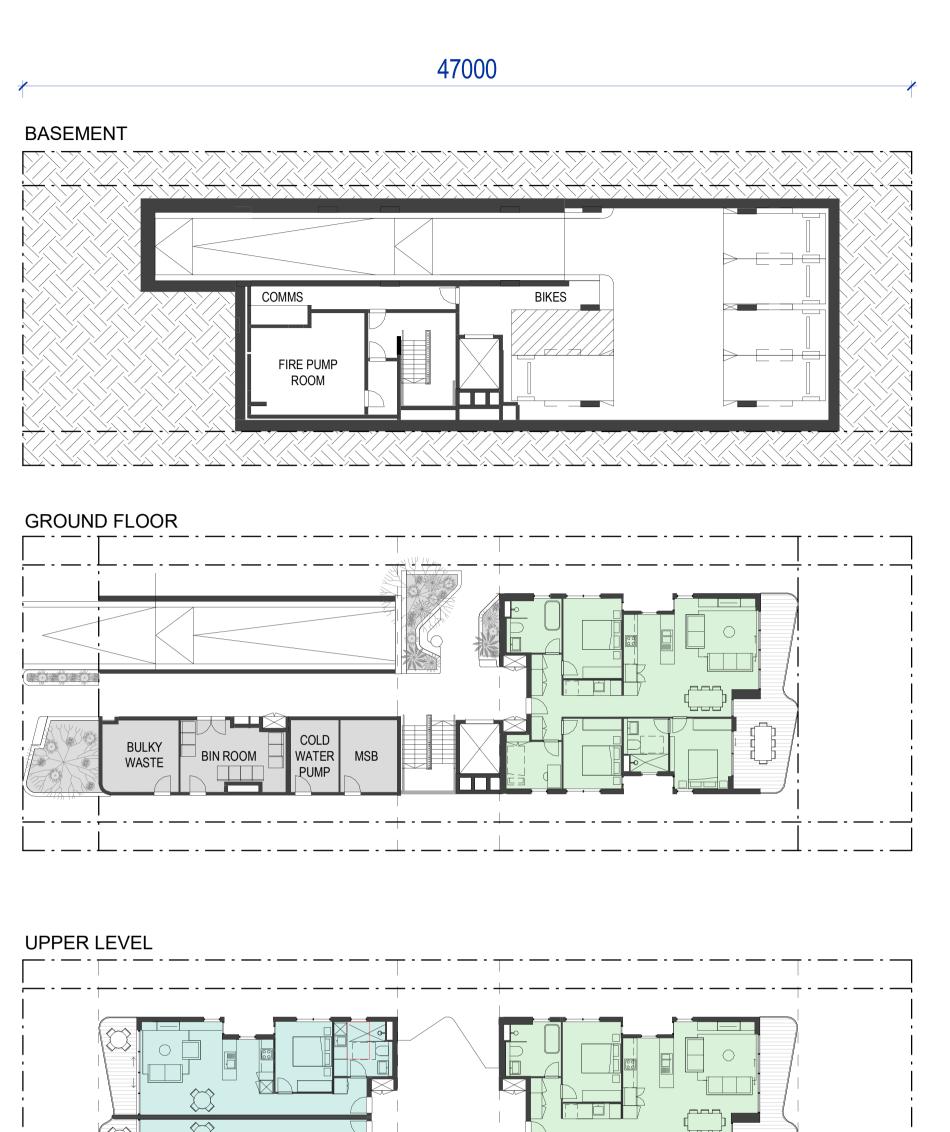



GFA		GFA		UNIT MIX		
RESIDENTIAL GFA		COMMUNAL & WA	STE ROOM	STUDIO	0 - 00.0%	0 - 00.0%
GROUND	118m ²	GROUND	91m ²	1B	6 - 60.0%	4 - 44.4%
LEVEL 01	245m ²	LEVEL 01	25m ²	2 B	0 - 00.0%	0 - 00.0%
LEVEL 02	245m ²	LEVEL 02	25m ²	3B	4 - 40.0%	5 - 55.6%
LEVEL 03	245m ²	LEVEL 03	25m ²			
ROOF	N/A	ROOF	N/A	TOTAL	10	9
TOTAL	853m ²	TOTAL	166m ²			

SITE AREA


TOTAL GFA


780.2m²

1019m²

1.31:1

PATTERN VARIANT: 52M SITE LENGTH

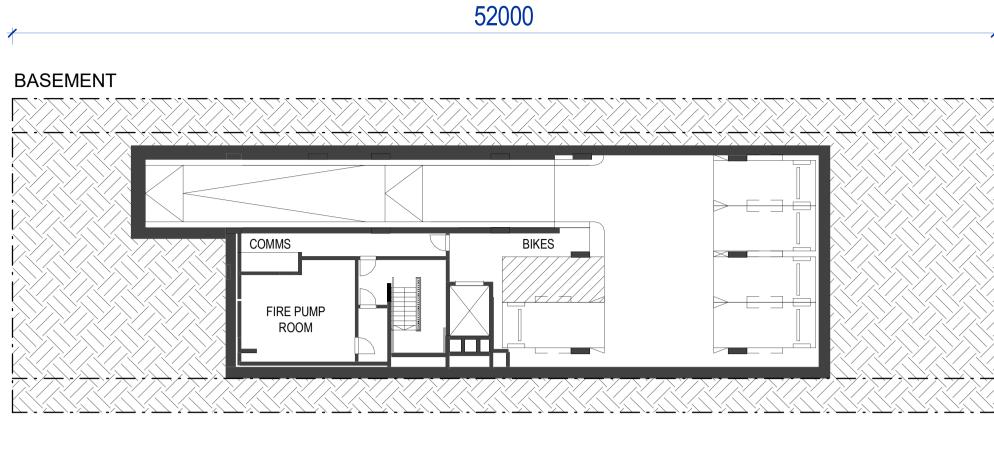

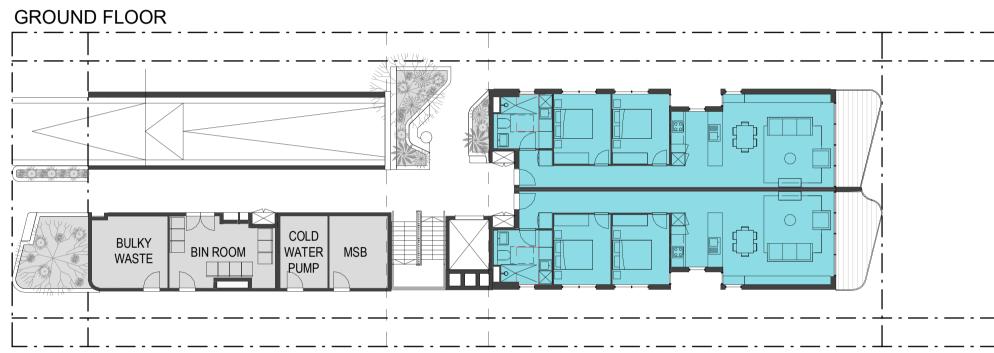



GFA DECIDENTIAL OF A		GFA	OTE DOOM	UNIT MIX		0 00 00/	
RESIDENTIAL GFA		COMMUNAL & WA		STUDIO	0 - 00.0%	0 - 00.0%	(
GROUND	164m ²	GROUND	91m ²	1B	2 - 18.2%	4 - 30.8%	(
LEVEL 01	291m ²	LEVEL 01	25m ²	2 B	8 - 72.6%	8 - 61.5%	8
LEVEL 02	291m ²	LEVEL 02	25m ²	3B	2 - 18.2%	1 - 07.7%	(
LEVEL 03	291m ²	LEVEL 03	25m ²				
ROOF	N/A	ROOF	N/A	TOTAL	11	13	1
TOTAL	1037m ²	TOTAL	166m ²				
TOTAL GFA	1203m ²						
FSR	1.39:1						

NSW HOUSING PATTERN BOOK

13600

SITE AREA

TOTAL GFA



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Rev	Date	Description	
Rev 1	Nov 2025	Pattern Book Issue	

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Gadigal Country Level 12, 126 Phillip Street, Sydney NSW 2000
. 04 0 000F 7400 Decention ON automorphism and a company

Level 12, 126 Phillip Street, Sydney NSW 2000
+61 2 8905 7100 Reception@Nguluway.designinc.com.au

Nominated Architects
Ian Armstrong 7260 Cathryn Drew-Bredin
Crain Kerslake 7789 Mary Appe McGirr

Pattern Code SLA02

Name Small L

863.2m²

SITE AREA


Small Lot Apartments 02 by Nguluway DesignInc

Drawing No.

Name LOT SIZE & MIX VARIANTS

A-206

Scale NTS

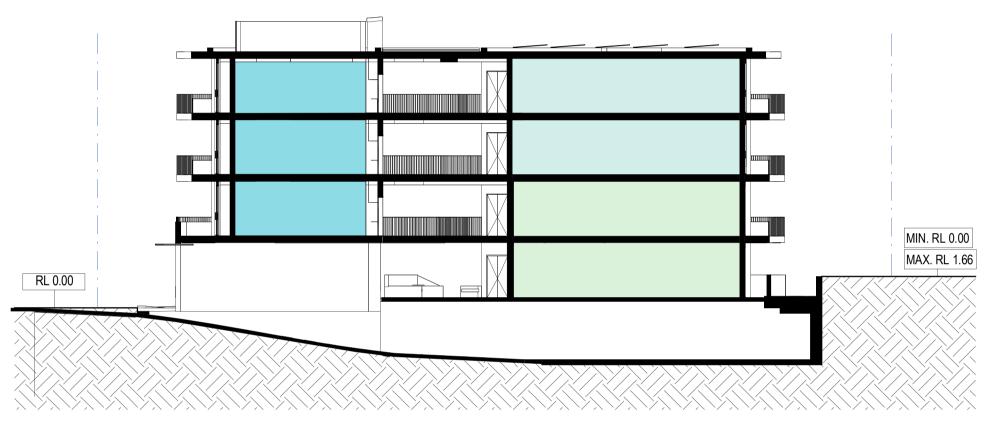


SECTION

Upslope adaptations (front-to-back)

Range: 0 to +1.66m

Basement parking ramp gradiant unchanged from Base Pattern.

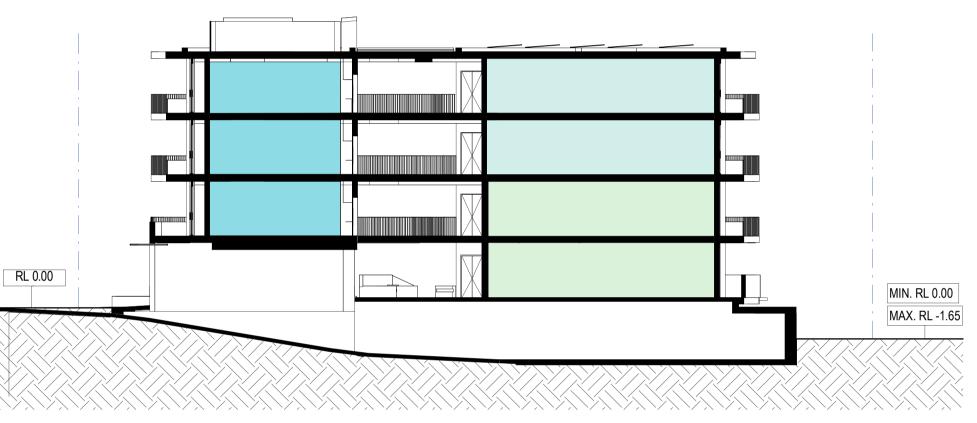

SECTION

Downslope adaptations (front-to-back)

Range: 0 to -1.65m

Basement parking ramp gradiant unchanged from Base Pattern.

NSW HOUSING PATTERN BOOK



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Pattern Code SLA02

Name Small Lot Apart

Small Lot Apartments 02
by Nguluway DesignInc

Drawing No.

Name

A-207

PATTERN ADAPTATIONS - TOPOGRAPHY

Scale 1:200 @ A1

SLOPE ADAPTATION

The base pattern can be adapted for

Upslope adaptations (front-to-back)

This references sites where the level at

the rear sits higher than the base level

Downslope adaptations (front-to-

This references sites where the level at


the rear sits lower than the base level at

level variations on site as shown.

at the street frontage.

the street frontage.

back)

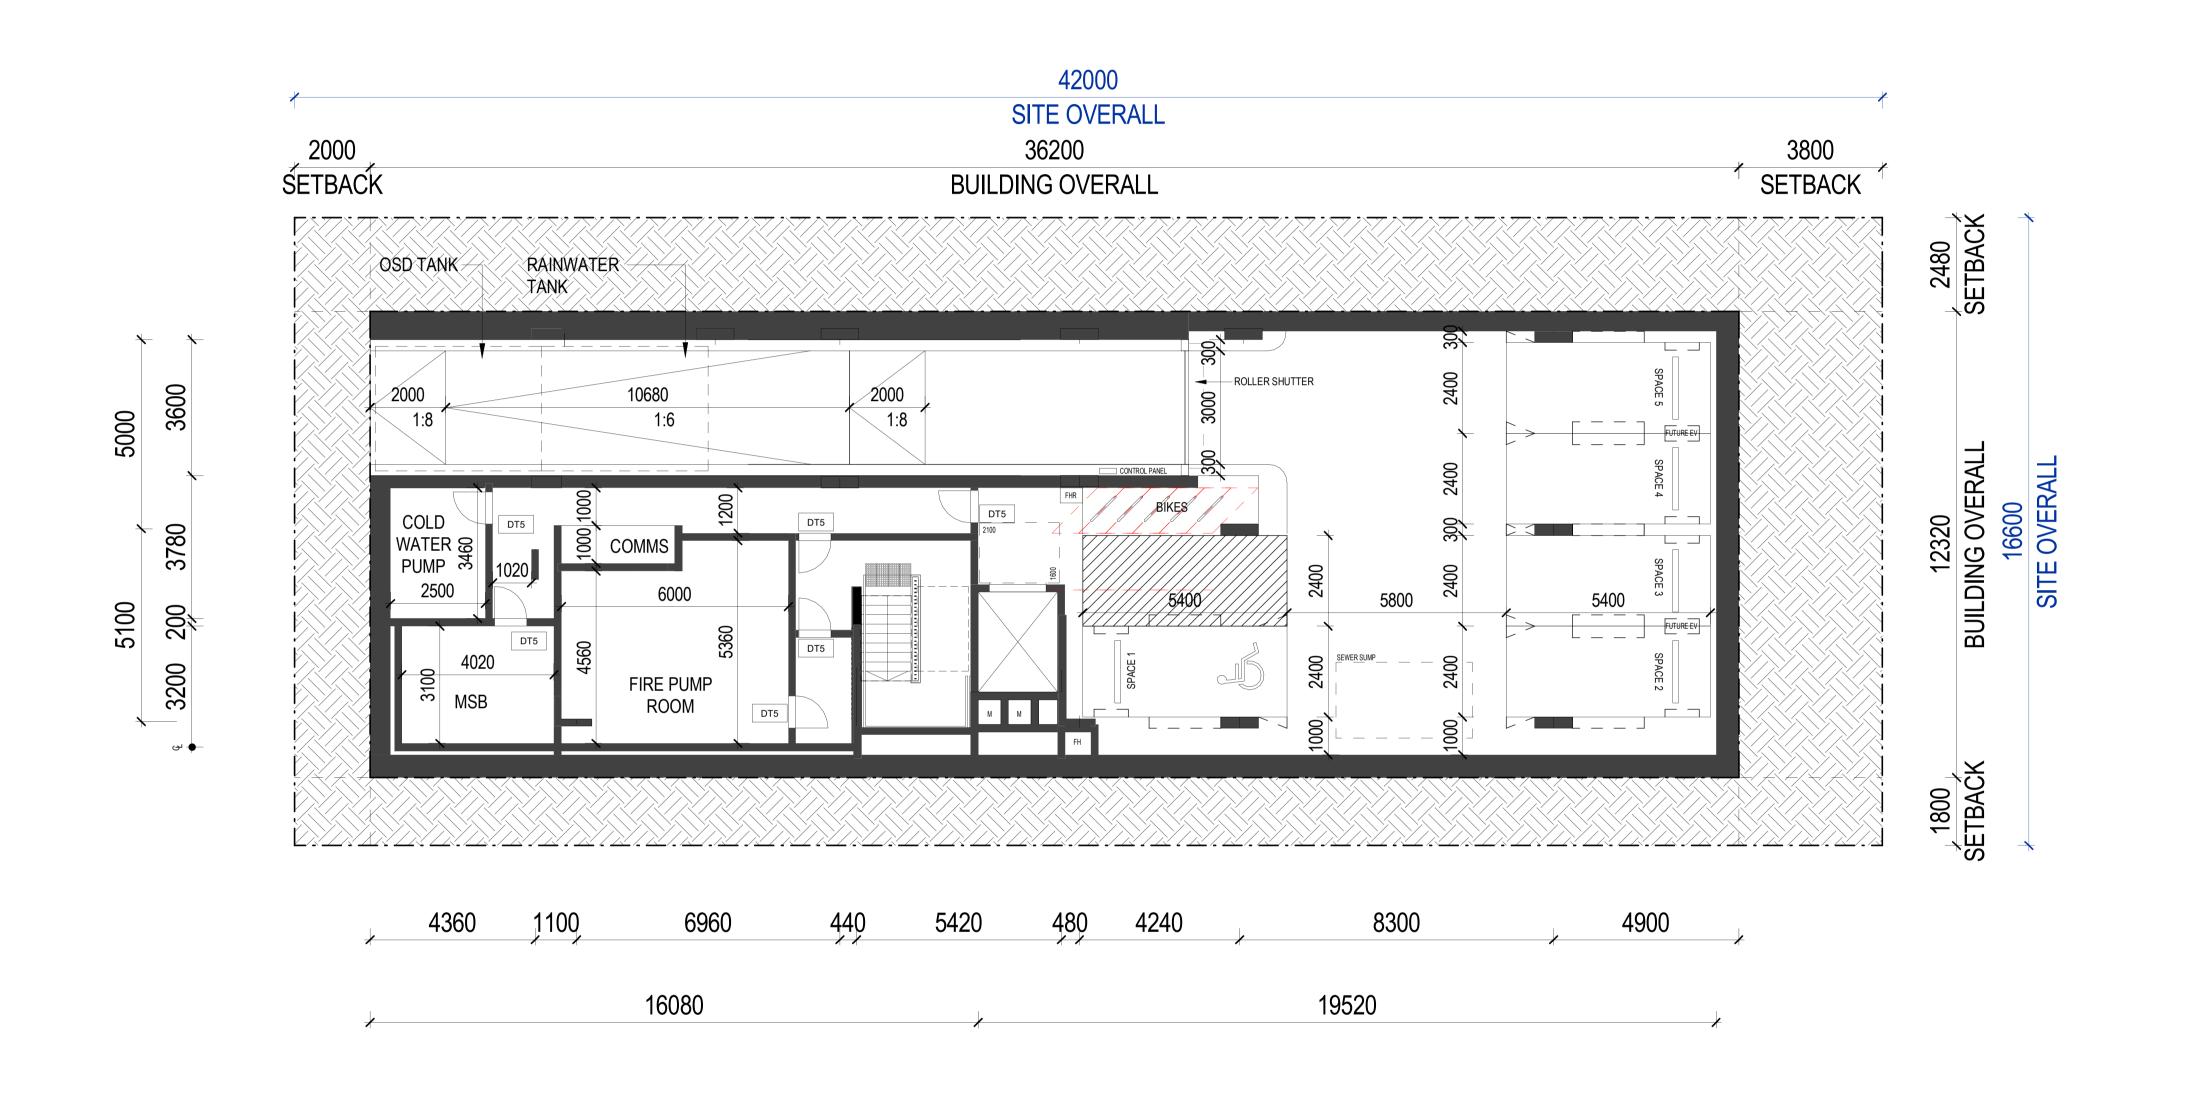

0 1 2 3 4 5 SCALE BAR - 1:100

ORIENTATION






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Rev 1	Nov 2025	Pattern Book Issue

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,	treet, Sydney NSW 2000
+61 2 8905 7100	Reception@Nguluway.designinc.com.au

Pattern Code	SLA02
Name	Small Lot Apartments 02
	by Nguluway DesignInc

rawing No.	A-310-1
ame	B01 PLAN – BASEMENT PARKING N/S

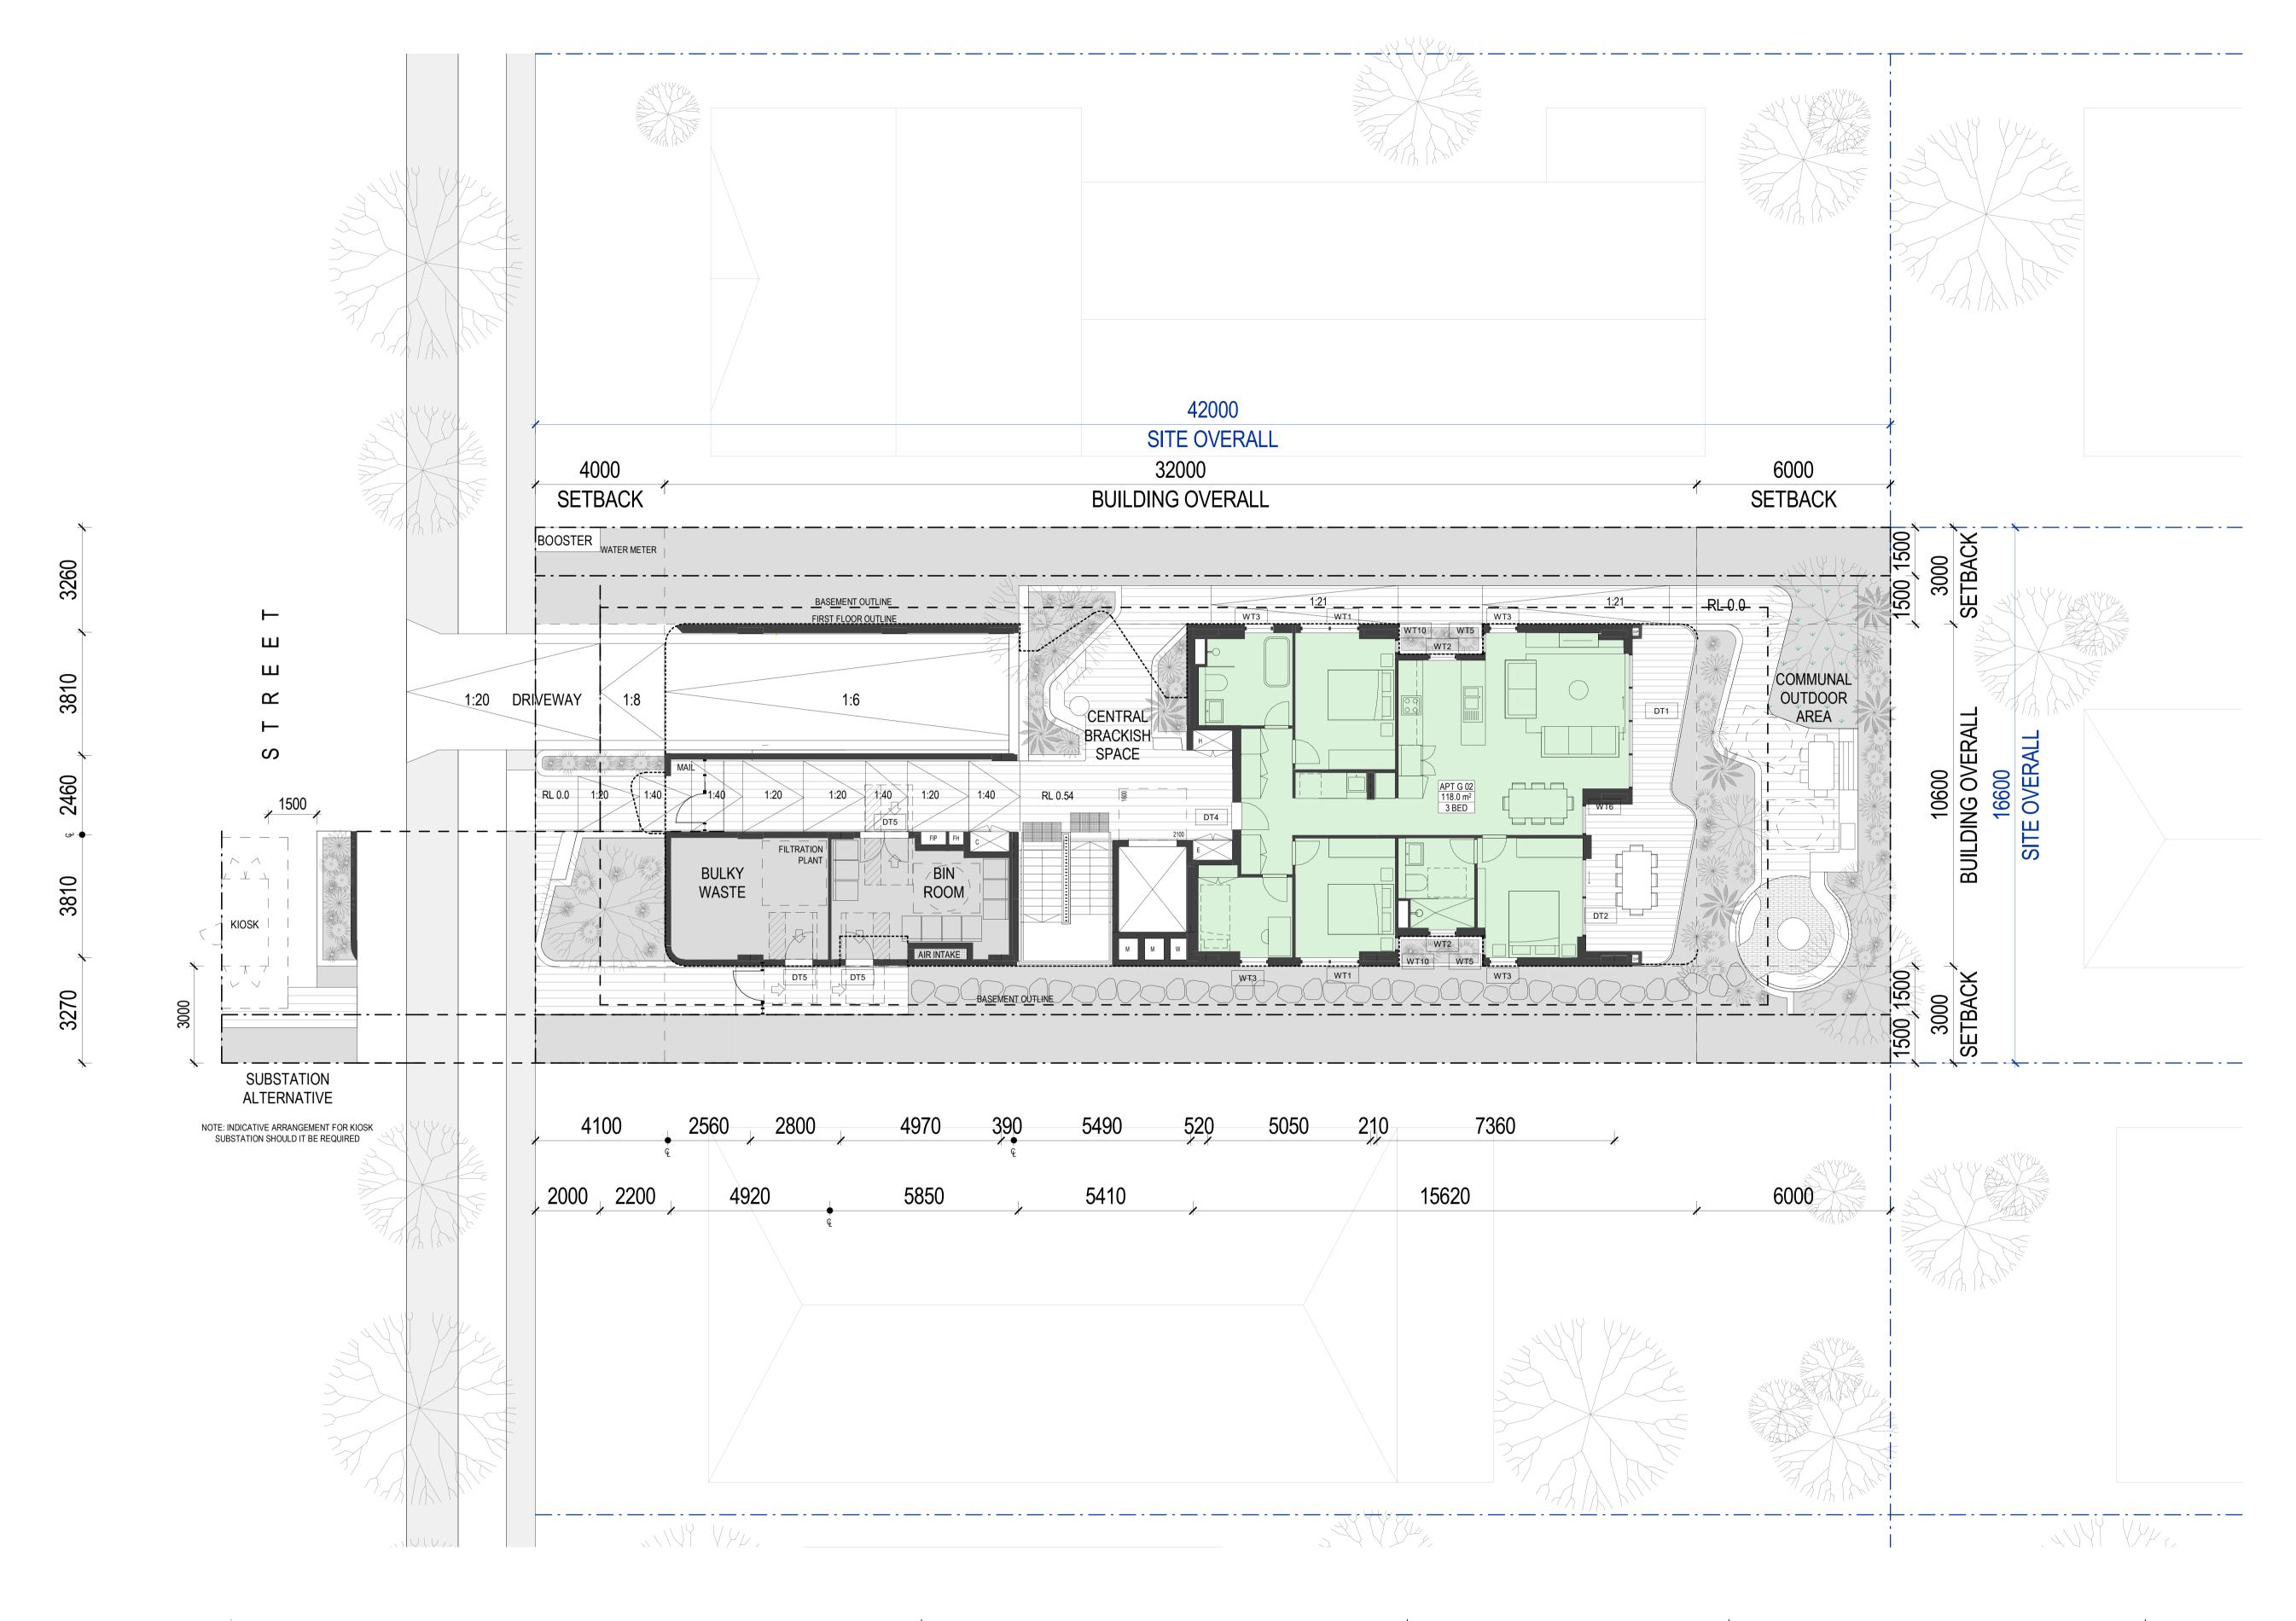

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			Gadigal Country Level 12, 126 Phillip Street, Sydney NSW +61 2 8905 7100 Reception@N

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Level 12, 126 Phillip Street, Sydney NSW 2000
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Nominated Architects
Ian Armstrong 7260 Cathryn Drew-Bredin
Craig Kerslake 7789 Mary Anne McGirr

Pattern Code SLA02

Name Small Lot Apartments 02
by Nguluway DesignInc

Drawing No.


Name

A-311-1

SCALE BAR - 1:100

L00 PLAN – BASEMENT PARKING N/S ORIENTATION

Scale 1:100 @ A1

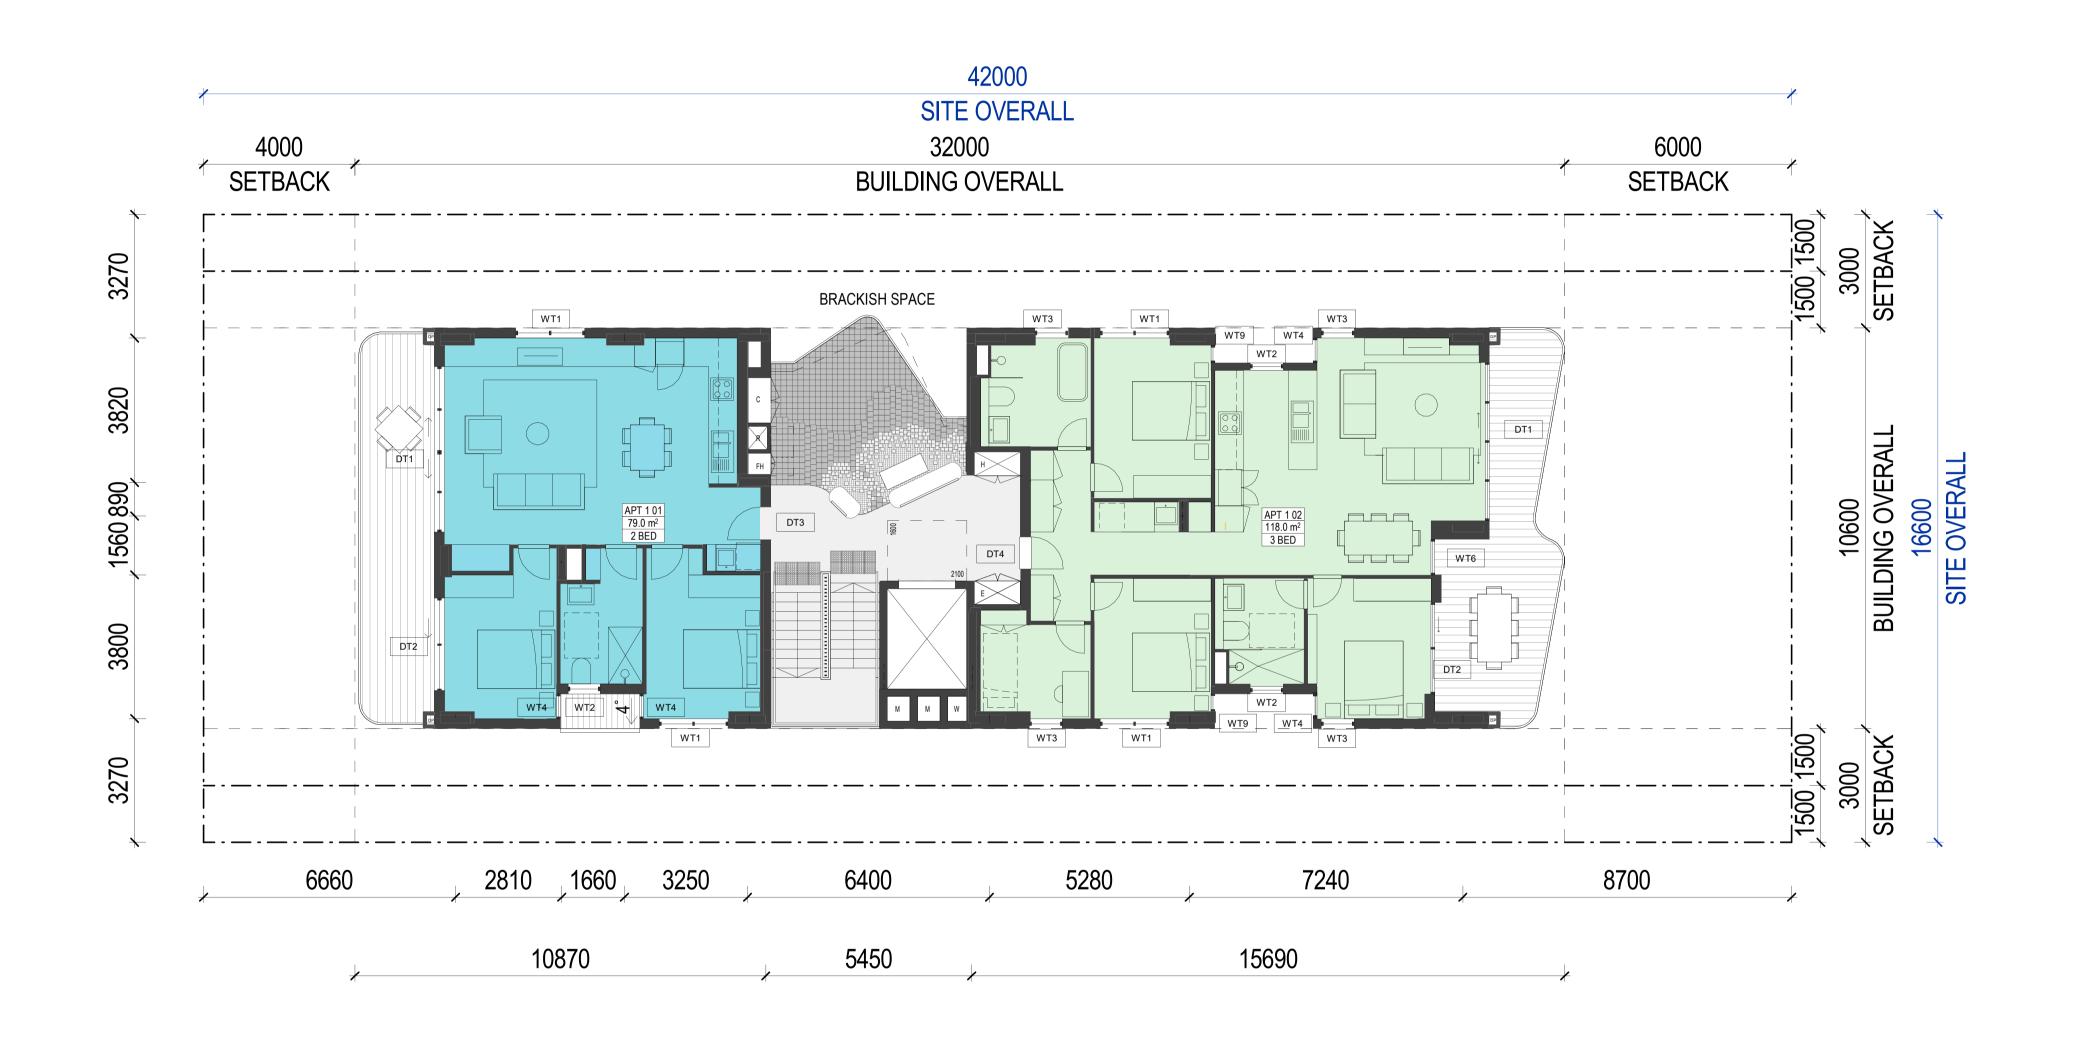

0 1 2 3 4 5 SCALE BAR - 1:100





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	-	


_	NGU	LU	WAYDes	ignInc
_	Gadigal Country Level 12, 126 Phillip St +61 2 8905 7100		NSW 2000 n@Nguluway.designinc.com.au	
_	Nominated Arch Ian Armstrong	<u>itects</u> 7260	Cathryn Drew-Bredin	7269

Pattern Code	SLA02
Name	Small Lot Apartments 02
	by Nguluway DesignInc

Drawing No.	A-312
Name	L01 PLAN – BASEMENT PARKING N/S ORIENTATION

Scale

1:100 @ A1

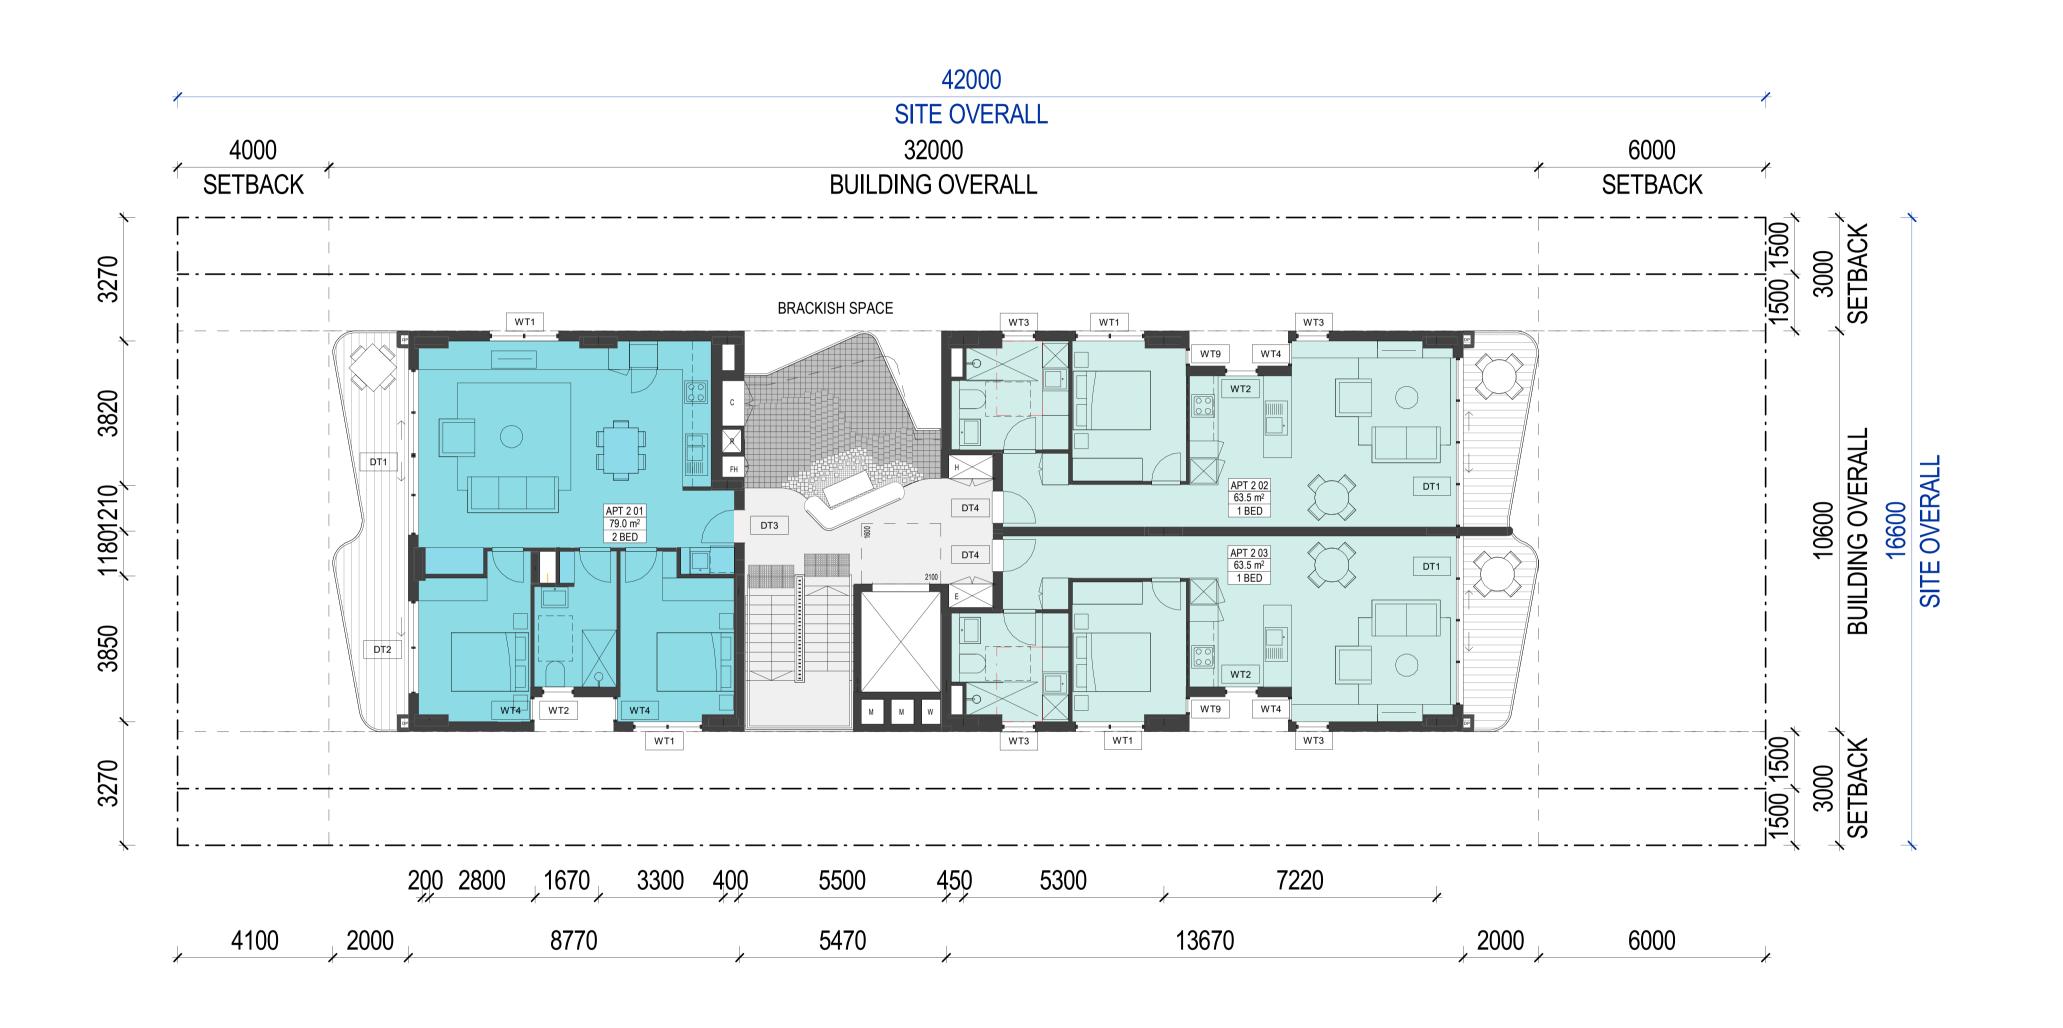

SCALE BAR - 1:100

NSW HOUSING PATTERN BOOK




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Rev 1	Nov 2025	Pattern Book Issue

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Nominated Arcl	<u>nitects</u> 7260	Cathryn Drew-Bredin	7269

Pattern Code	SLA02
Name	Small Lot Apartments 02
	by Nguluway DesignInc

Drawing No.	A-313
Name	L02 PLAN – BASEMENT PARKING N/S ORIENTATION
Scale	NTS

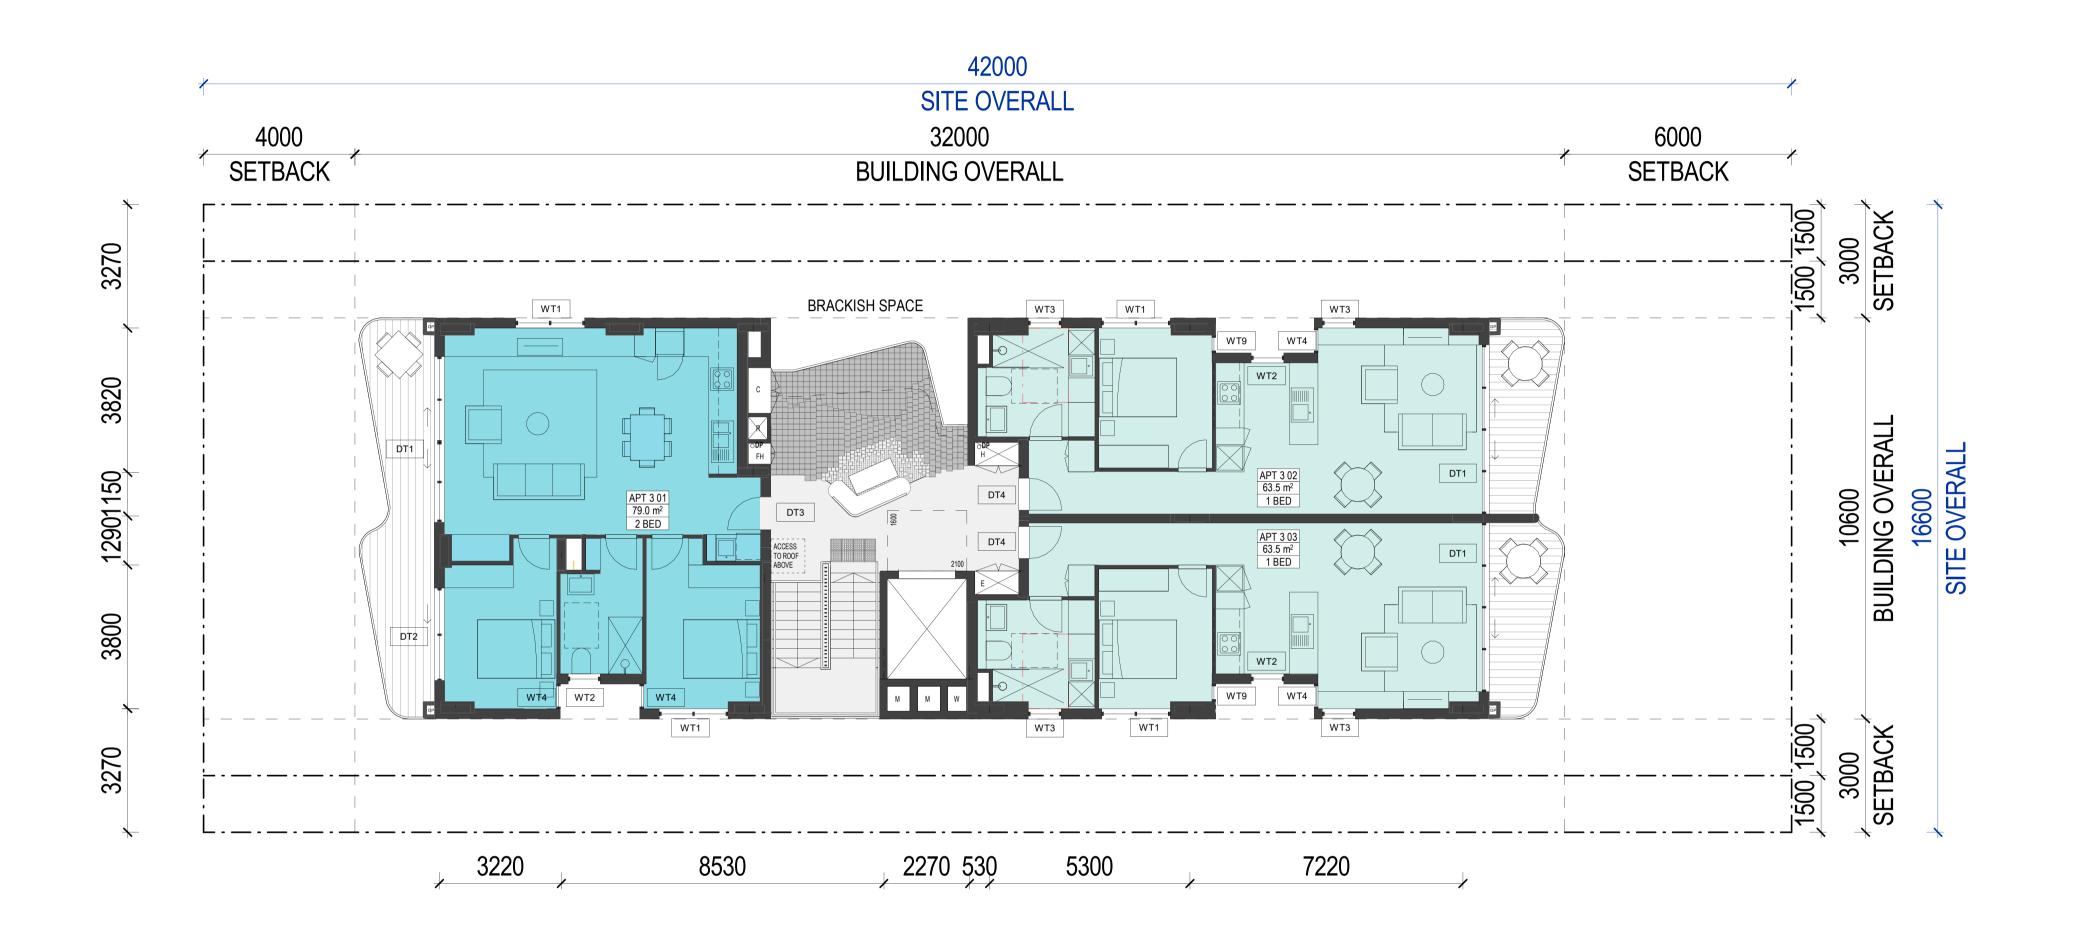

0 1 2 3 4 5 SCALE BAR - 1:100

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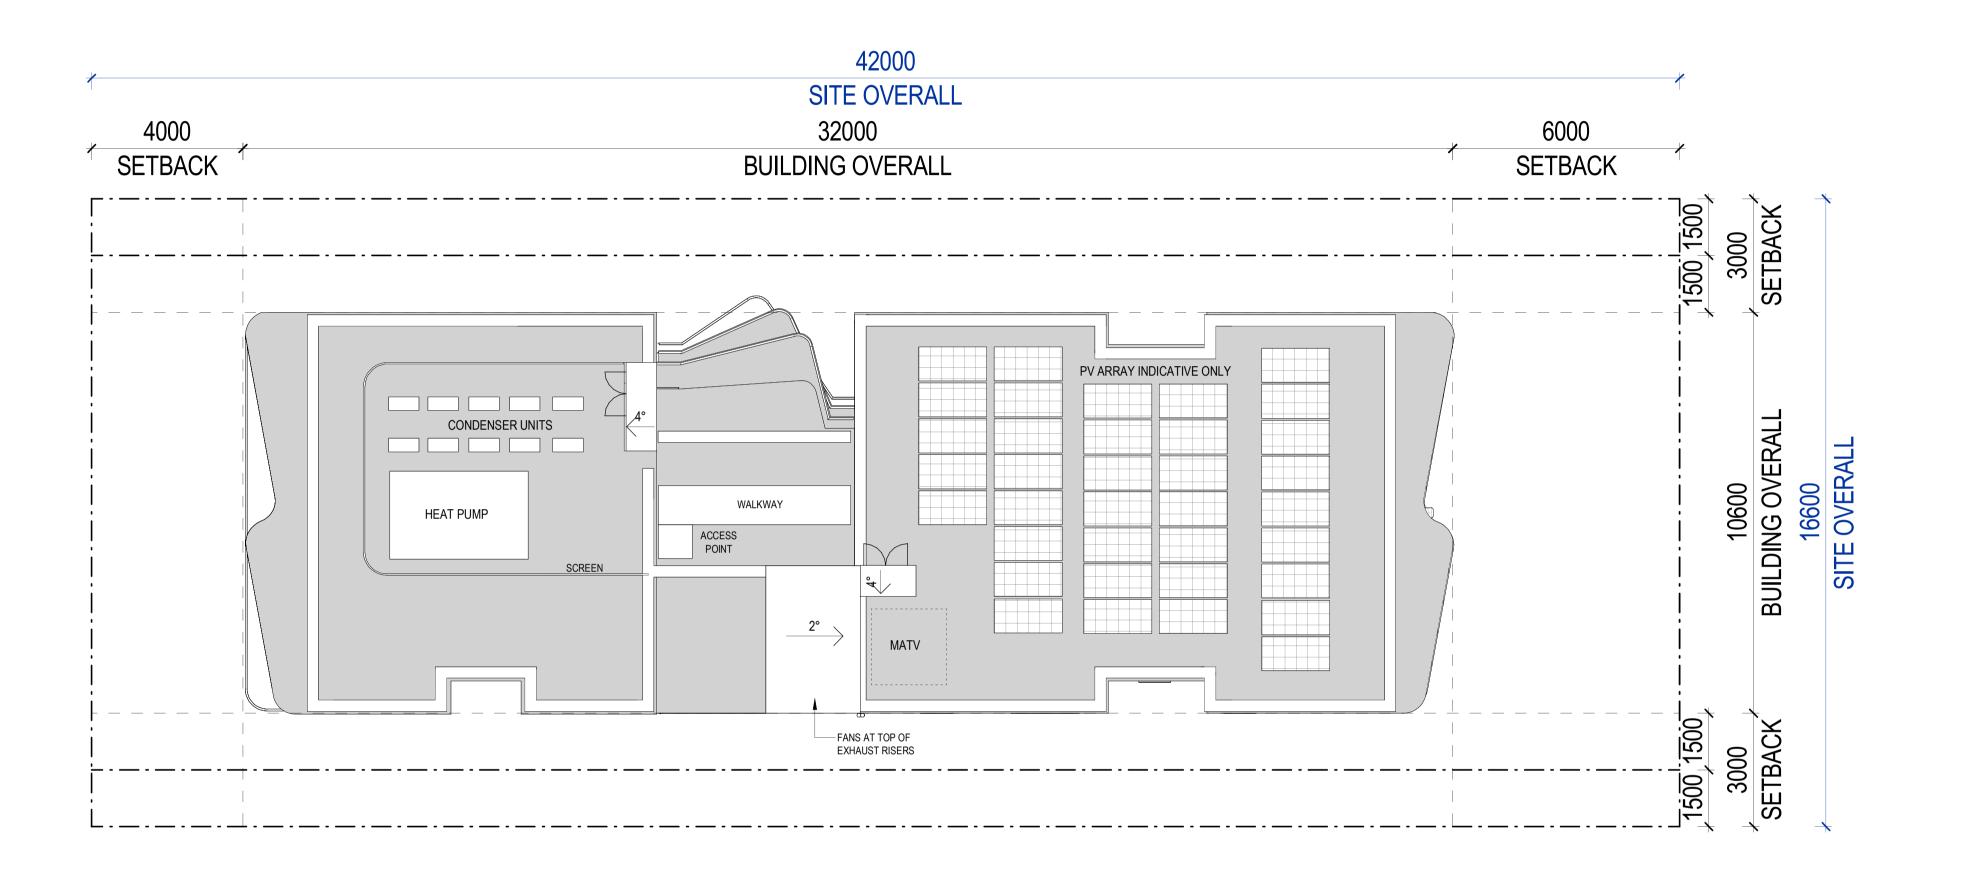
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Nominated Architects Jan Armstrong 7260 Cathryn Drew-Bredin 7269


Pattern Code	SLA02
Name	Small Lot Apartments 02
	by Nguluway DesignInc

Drawing No.	A-314
Name	L03 PLAN – BASEMENT PARKING N/S ORIENTATION

Scale

1:100 @ A1



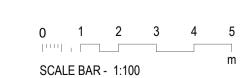





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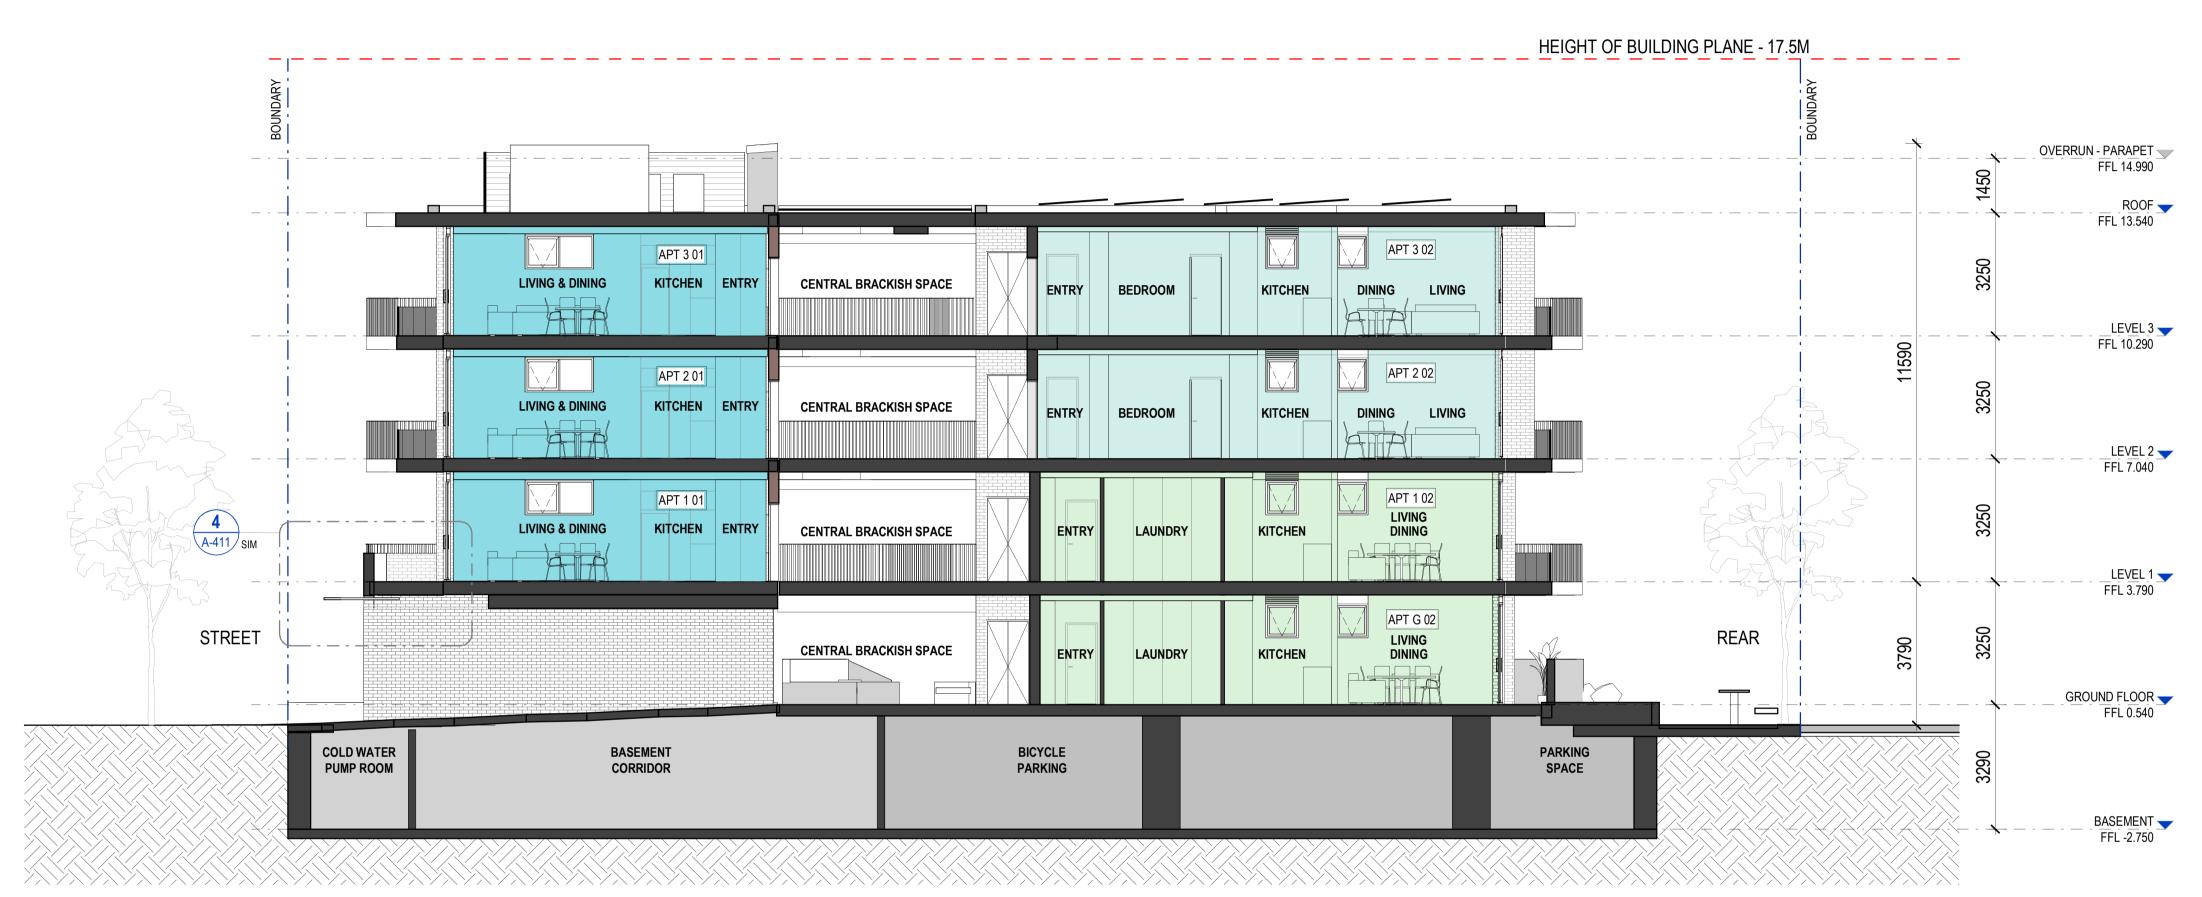
Rev	Date	Description	
Rev 1	Nov 2025	Pattern Book Issue	

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Nominated Architects Jan Armstrong 7260 Cathryn Drew-Bredin 7269

attern oode	OLAUZ
Name	Small Lot Apartments 02
	by Nguluway DesignInc

Drawing No.	A-315
Name	ROOF PLAN – BASEMENT PARKING N/S ORIENTATION

Elevations and sections



1 DA - SECTION A-A - BASEMENT PARKING

0 1 2 3 4 5 SCALE BAR - 1:100

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Rev 1	Nov 2025	Pattern Book Issue	


-	NGU	LU	WAYDes	signInc
_	Gadigal Country Level 12, 126 Phillip +61 2 8905 7100		NSW 2000 @Nguluway.designinc.com.au	
_	Nominated Ard Ian Armstrong Crain Kerslake	7260	Cathryn Drew-Bredin Mary Anne McGirr	7269 10946

Pattern Code	SLA02
Name	Small Lot Apartments 02
	by Nguluway DesignInc

Drawing No.	A-350
Name	SECTION A-A

Scale

1:100 @ A1

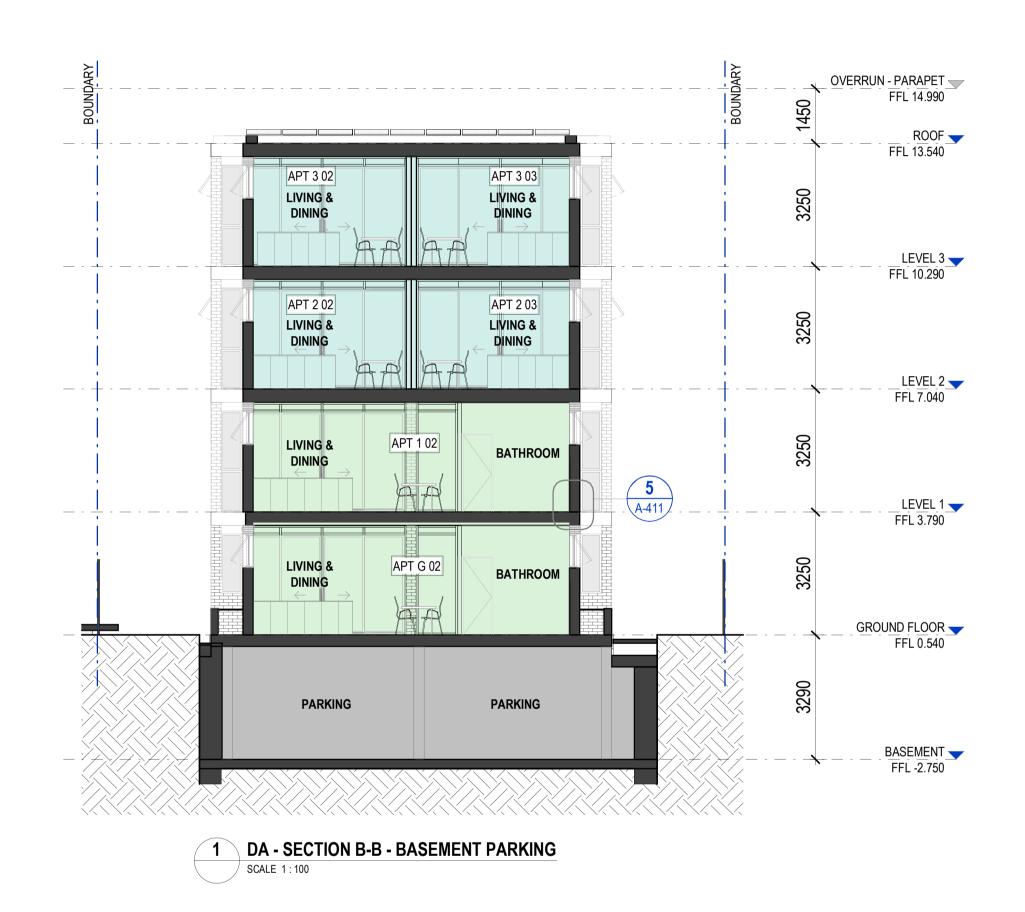

0 1 2 3 4 5 SCALE BAR - 1:100

1:100 @ A1

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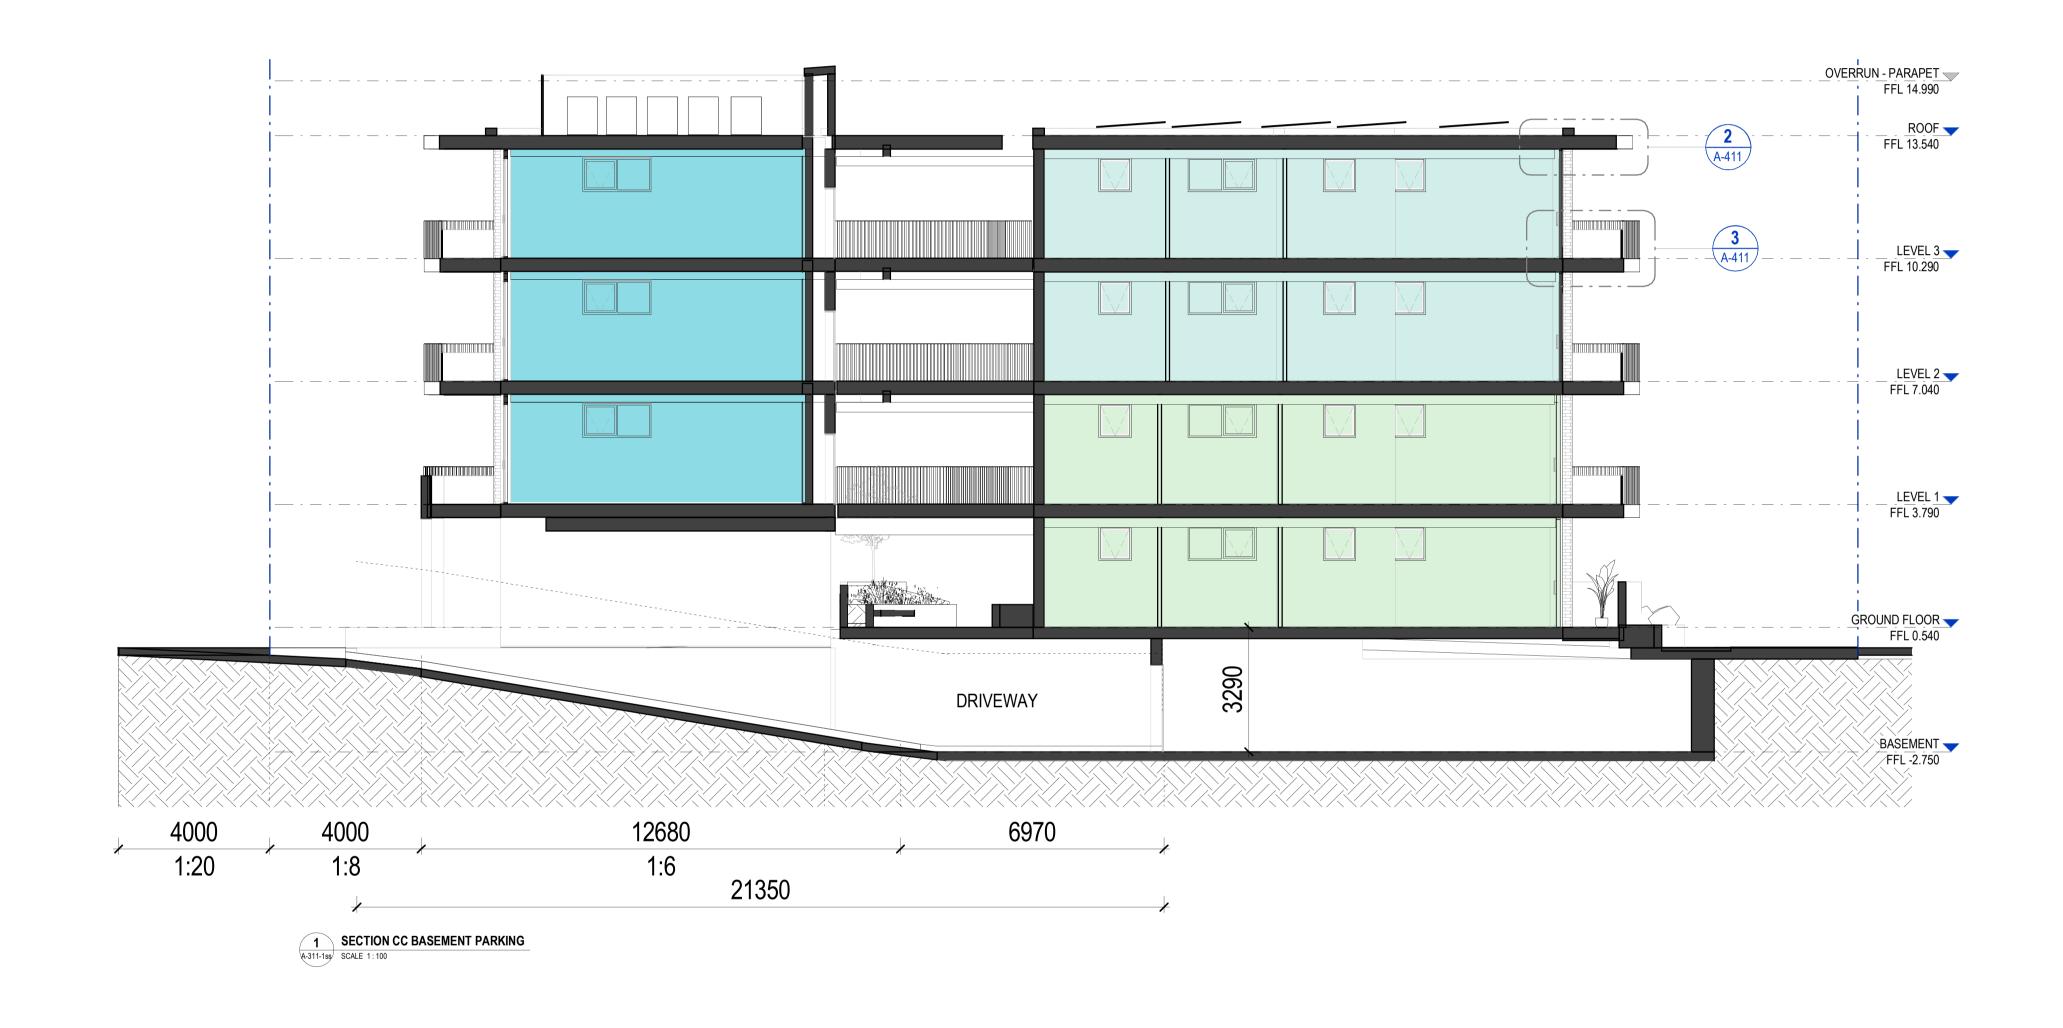
Rev	Date	Description	
Rev 1	Nov 2025	Pattern Book Issue	

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,	reet, Sydney NSW 2000
+61 2 8905 7100	Reception@Nguluway.designinc.com.au

Pattern Code	SLA02	
Name	Small Lot Apartments 02	N
	by Nguluway DesignInc	

Drawing No.	A-351
Name	SECTION B-B

Scale



0 1 2 3 4 5 SCALE BAR - 1:100

1:100 @ A1





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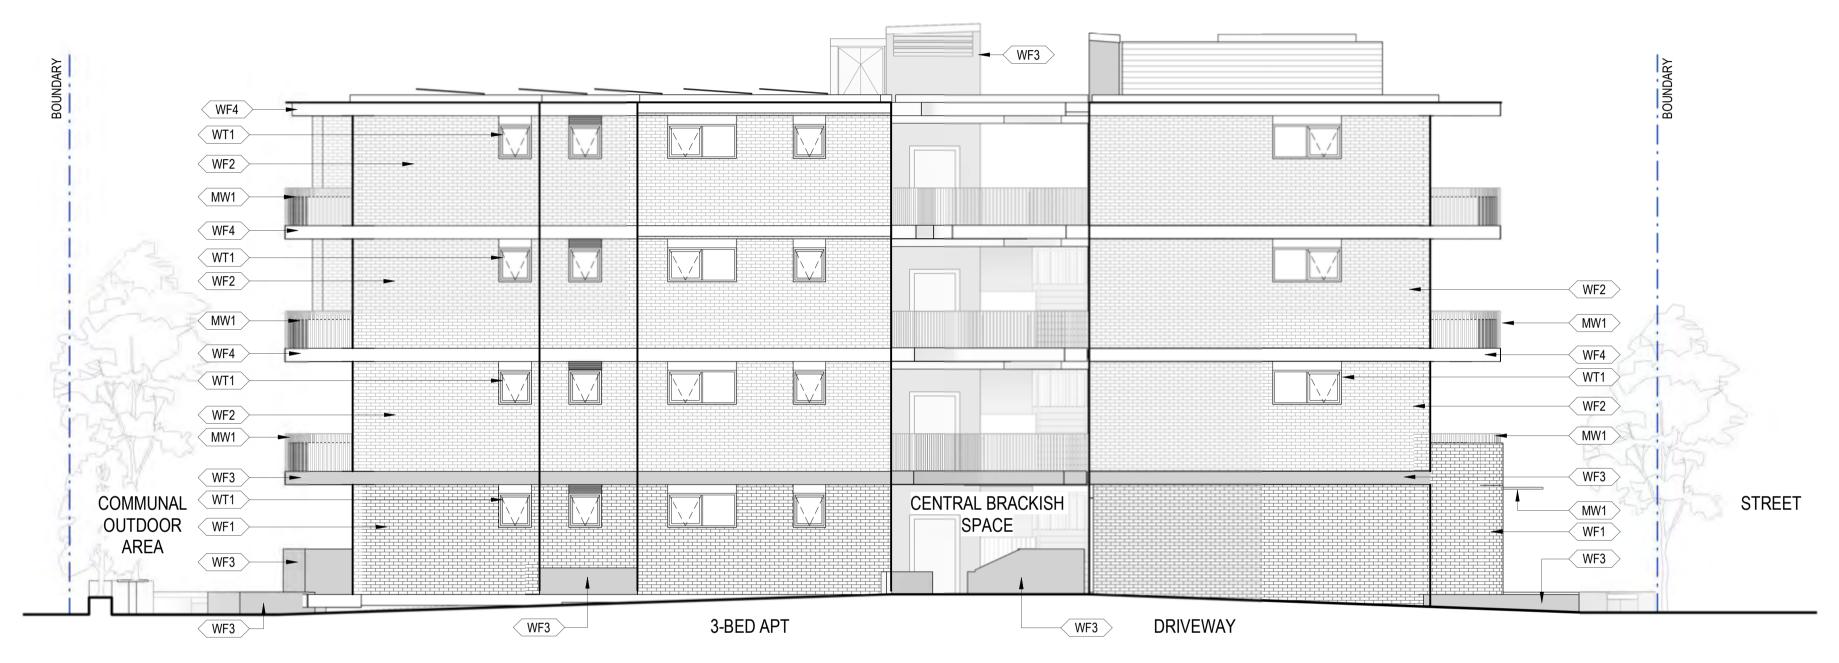
Rev 1 Nov 2025 Pattern Book Issue

Gadigal Country Level 12, 126 Phillip Street, Sydney NSW 2000 +61 2 8905 7100 Reception@Nguluway.designinc.com.au Nominated Architects Ian Armstrong 7260 Cathryn Drew-Bredin 7269	NGU	\mathbf{I}	WAYDes	ianln
	Gadigal Country Level 12, 126 Phillip	Street, Sydney N	NSW 2000	9
Ian Armstrong 7260 Cathryn Drew-Bredin 7269	Nominated Arc	hitects		
Craig Kerslake 7789 Mary Anne McGirr 10946	•		,	

Pattern Code	SLA02
Name	Small Lot Apartments 02
	by Nguluway DesignInc

Drawing No.	A-352
Name	SECTION C-C

Scale



1 NORTH ELEVATION
SCALE 1:100

0 1 2 3 4 5 SCALE BAR - 1:100

NSW HOUSING PATTERN BOOK


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Pattern Code	SLA02
Name	Small Lot Apartments 0
	by Nguluway DesignInc

rawing No.	A-360-1
lame	NORTH ELEVATION AND ADAPTATIONS



1 SOUTH ELEVATION
SCALE 1:100

0 1 2 3 4 5 SCALE BAR - 1:100

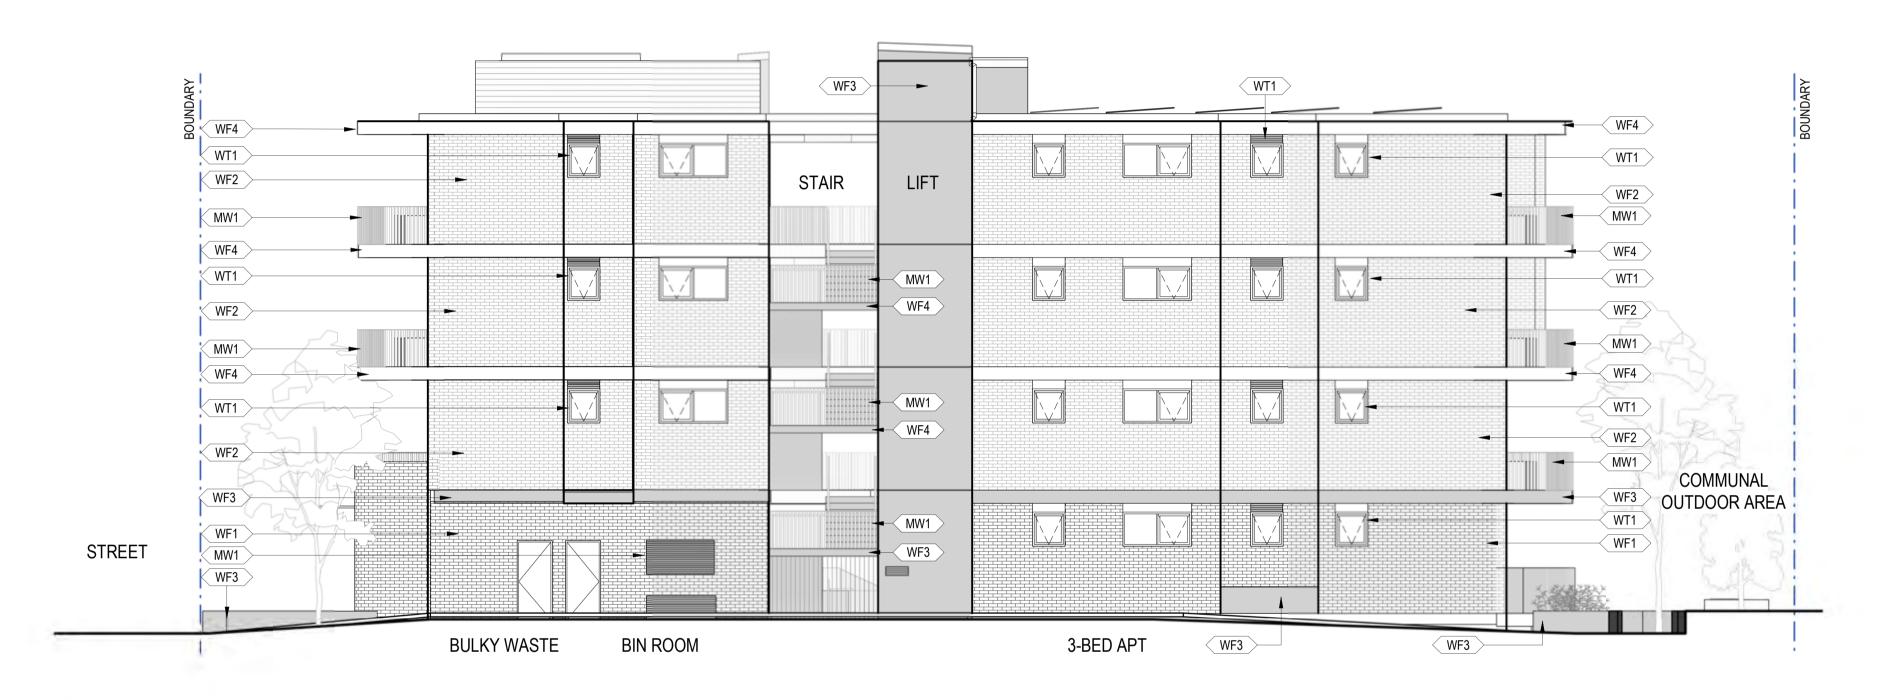SOUTH ELEVATION

A-360-2

1:100 @ A1

NSW HOUSING PATTERN BOOK


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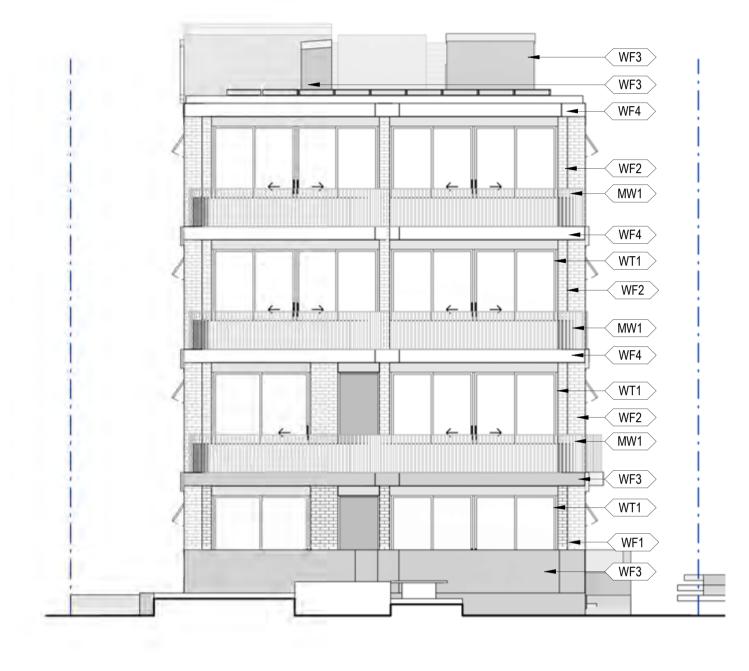
Rev 1 Nov 2025 Pattern Book Issue	Rev	Date	Description
	Rev 1	Nov 2025	Pattern Book Issue

_	NGU	LU	WAYDes	signInc
- -	Gadigal Country Level 12, 126 Phillip +61 2 8905 7100	Street, Sydney N		
_	Nominated Ard	chitects 7260	Cathryn Drew-Bredin	7269
	Ozaia Kazalaka	7700	Mari Anna MaCim	10040

Pattern Code	SLA02	Drawing No.
Name	Small Lot Apartments 02 by Nguluway DesignInc	Name
		Scale





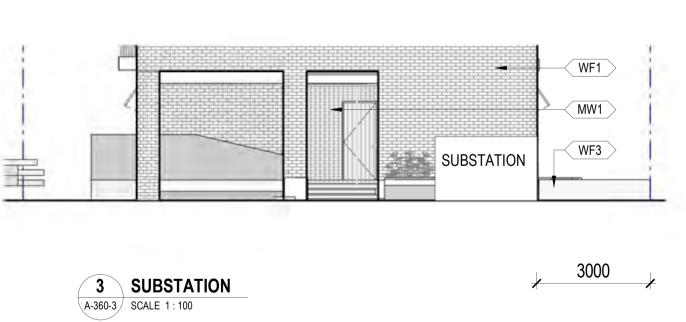

5 EAST ELEVATION SCALE 1:100

NSW HOUSING PATTERN BOOK

GOVERNMENT ARCHITECT NEW SOUTH WALES

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Cathryn Drew-Bredin Mary Anne McGirr


SLA02

0 1 2 3 4 5

SCALE BAR - 1:100

A-360-3 Pattern Code Drawing No. **ELEVATIONS AND Small Lot Apartments 02** Name Name **ADAPTATIONS** by Nguluway DesignInc Scale 1:100 @ A1

Typical apartments

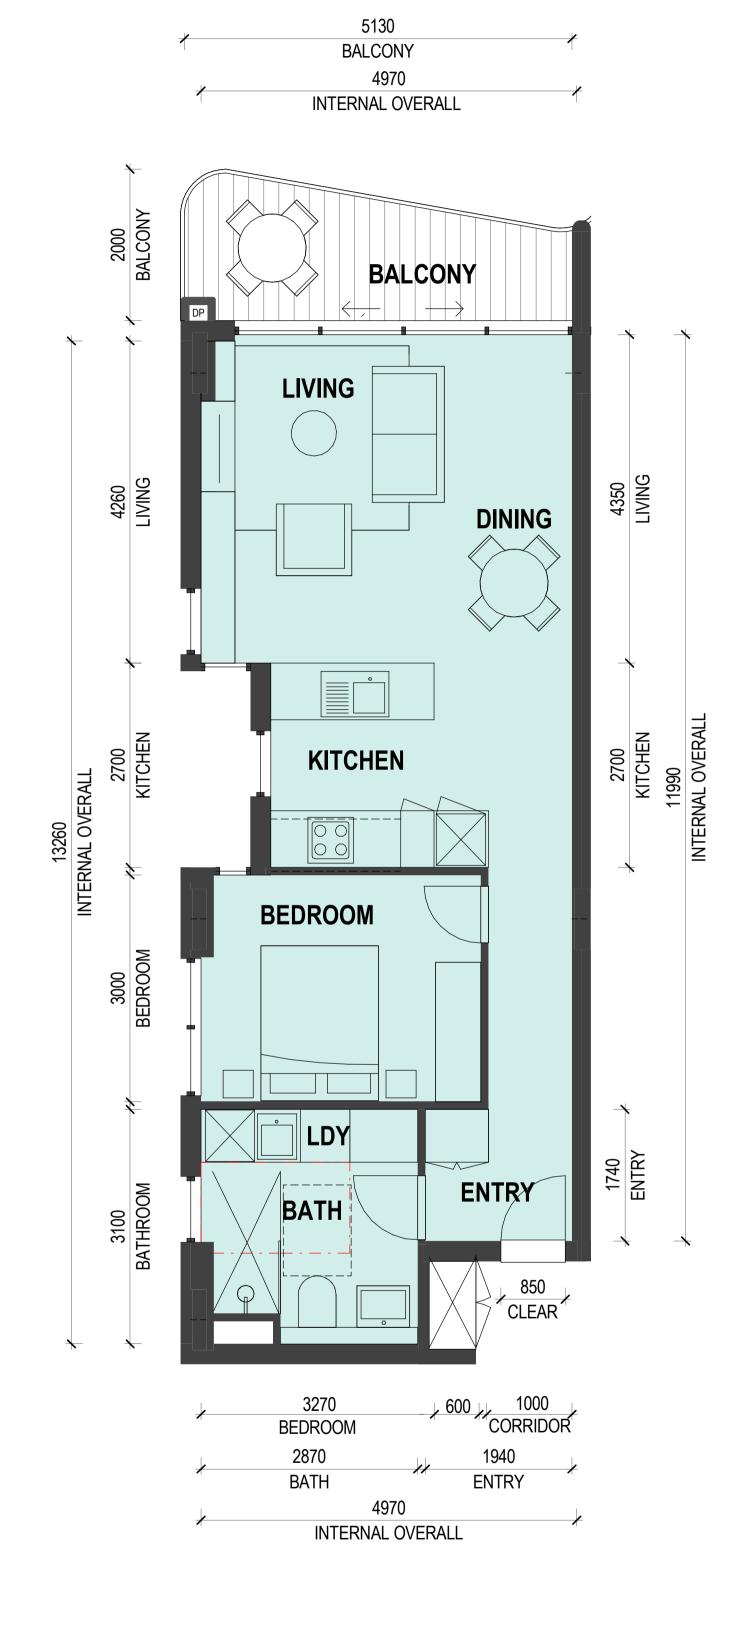

Apartment Type	1B_1
Apartment Type	1 Bedroom
Internal Area	59m ²
Balcony Area	8.6m ²
Internal storage volume	7m ³
External storage volume	0m ³
ACBC Livable Housing Design standard	Standard for livable housing design
AS4299 Adaptable	
Kitchen Type	K_1

0 500 1000 1500 2000 250 SCALE BAR - 1:50

NSW HOUSING PATTERN BOOK

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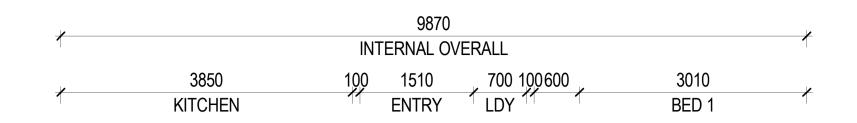
Rev	Date	Description
Rev 1	Nov 2025	Pattern Book Issue
-		

_	NGULUWAY DesignInc
_	Gadigal Country
	Level 12, 126 Phillip Street, Sydney NSW 2000
	+61 2 8905 7100 Reception@Nguluway.designinc.com.au
	Name in stand. Application

Cathryn Drew-Bredin Mary Anne McGirr


Pattern Code	SLA02
Name	Small Lot Apartments 02
	by Nguluway DesignInc

Drawing No.	A-370-1
Name	APARTMENT PLANS





Apartment Type	2B_1 Pre-Adaptable
Apartment Type	2 Bedroom
Internal Area	79m ²
Balcony Area	16.8m ²
Internal storage volume	12.7m ³
External storage volume	0m²
ACBC Livable Housing Design standard	Standard for livable housing design
AS4299 Adaptable	
Kitchen Type	K_2

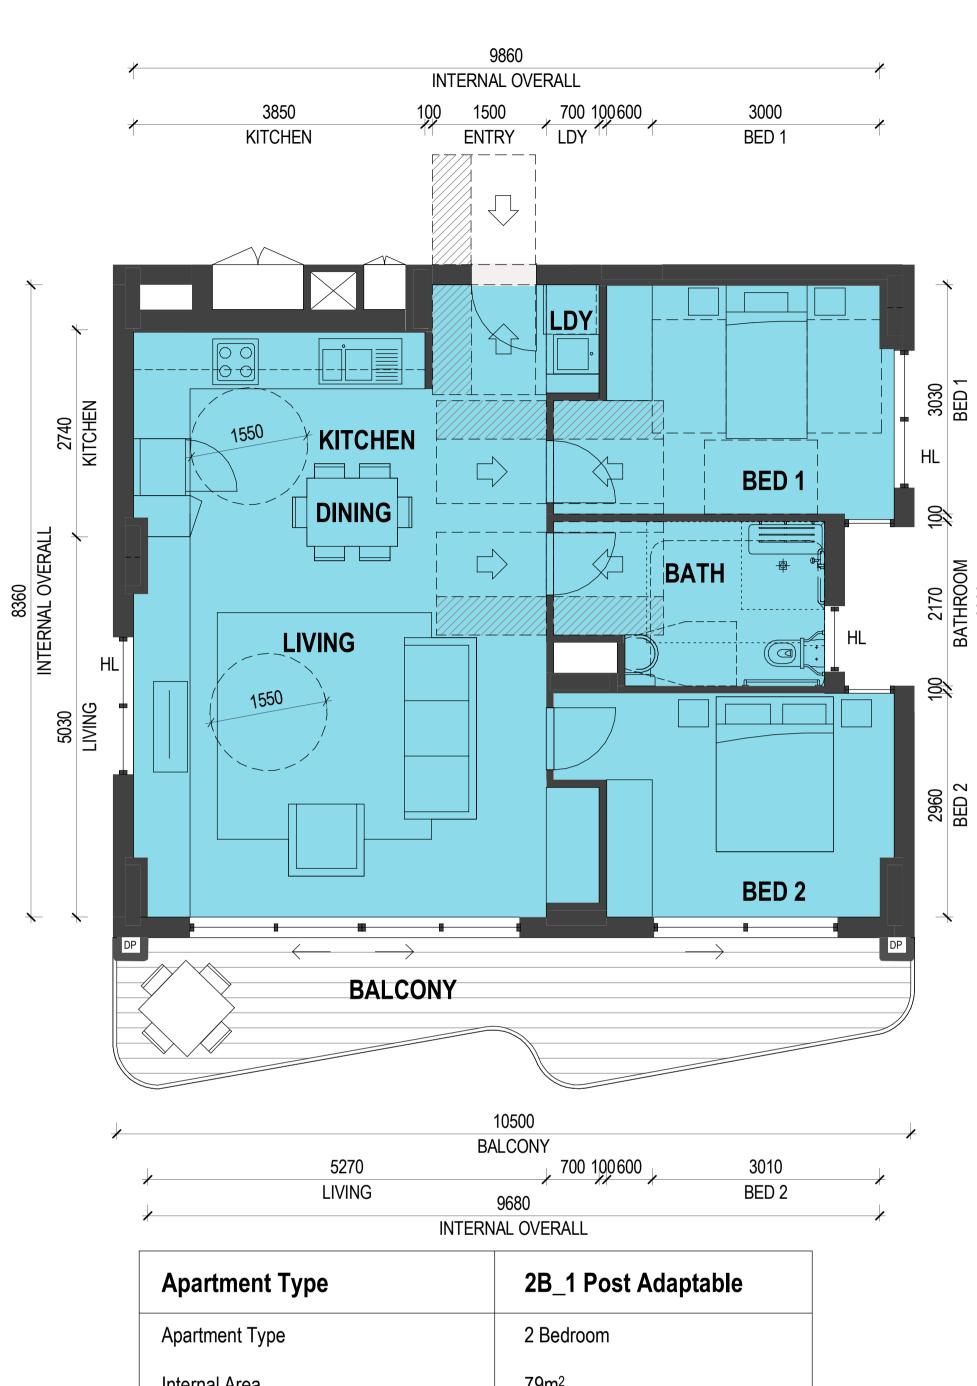

Apartment Type	2B_1 Post Adaptable
Apartment Type	2 Bedroom
Internal Area	79m²
Balcony Area	16.8m ²
Internal storage volume	12.7m ³
External storage volume	0m ²
ACBC Livable Housing Design standard	Standard for livable housing design
AS4299 Adaptable	Yes
Kitchen Type	K_2

o 500 1000 1500 2000 2500

SCALE BAR - 1:50

1:50 @ A1

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<u>s</u> ,				

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Nominated Architects

Cathryn Drew-Bredin

Mary Anne McGirr

Pattern Code	SLA02
Name	Small Lot Apartments 02
	by Nguluway DesignInc

Drawing No.	A-370-2	

POST ADAPTABLE KEY

1000

1530

850140

1450

Name	APARTMENT ADAPTATION PLANS

Scale



0	500	1000	1500	2000	2500
him	1				
SCA	LE BAR	2 - 1:50			mm



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3B_1

116m²

24m²

10.3m³

 $0m^3$

K_3

3 Bedroom

Apartment Type

Internal storage volume

External storage volume

AS4299 Adaptable

Kitchen Type

ACBC Livable Housing Design standard

Apartment Type

Internal Area

Balcony Area


Rev	Date	Description
Rev 1	Nov 2025	Pattern Book Issue

NGU	LUWAY DesignIn
Gadigal Country	
Level 12. 126 Phillip St	reet, Sydney NSW 2000
+61 2 8905 7100	Reception@Nguluway.designinc.com.au

Pattern Code	SLA02
Name	Small Lot Apartments 02
	by Nguluway DesignInc

Drawing No.	A-370-3
Name	APARTMENT PLANS

1:50 @ A1 Scale

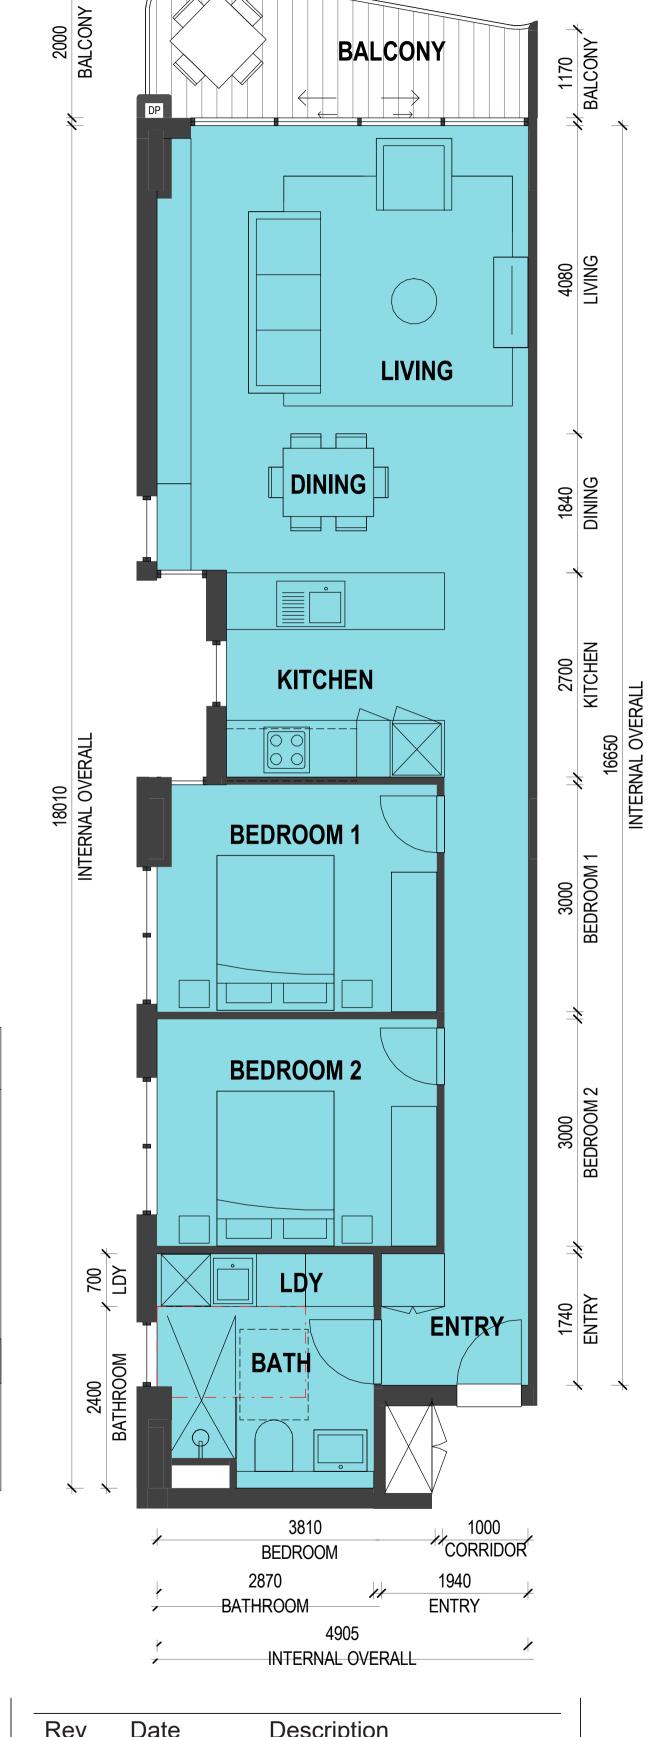

5300 BALCONY

LIVING

Apartment Type	2B_2
Apartment Type	2 Bedroom
Internal Area	82m ²
Balcony Area	8.6m ²
Internal storage volume	10m ³
External storage volume	0m ²
ACBC Livable Housing Design standard	Standard for livable housing design
AS4299 Adaptable	
Kitchen Type	K_1

NSW HOUSING PATTERN BOOK

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NGULUWAY DesignInc

Gadigal Country Level 12, 126 Phillip Street, Sydney NSW 2000 +61 2 8905 7100 Reception@Nguluway.designinc.com.au Cathryn Drew-Bredin

Name

0 500 1000 1500 2000 2500 SCALE BAR - 1:50

SLA02 A-370-3 Pattern Code Drawing No. **APARTMENT PLANS Small Lot Apartments 02** Name by Nguluway DesignInc 1:50 @ A1 Scale


Renders and materials

MATERIAL PALETTE GUIDE

How geology informs materiality

The building is designed as having a 'base' (Ground) and 'upper' (L1 and above). The 'base' and 'upper' stratas should be darker and lighter tones of the primary colour respectively, achieving a noticeable difference between the two.

The intent is that each strata is read as a uniform coloured block. Where a finish is part of the base, it should match the base colour material i.e. brick selection, mortar joints, metalwork (including window frames), paintwork etc. Where a finish is part of the 'upper', it should similarly be coloured to match the lighter tone, with the exception of metalwork which should be consistent across both base and upper.

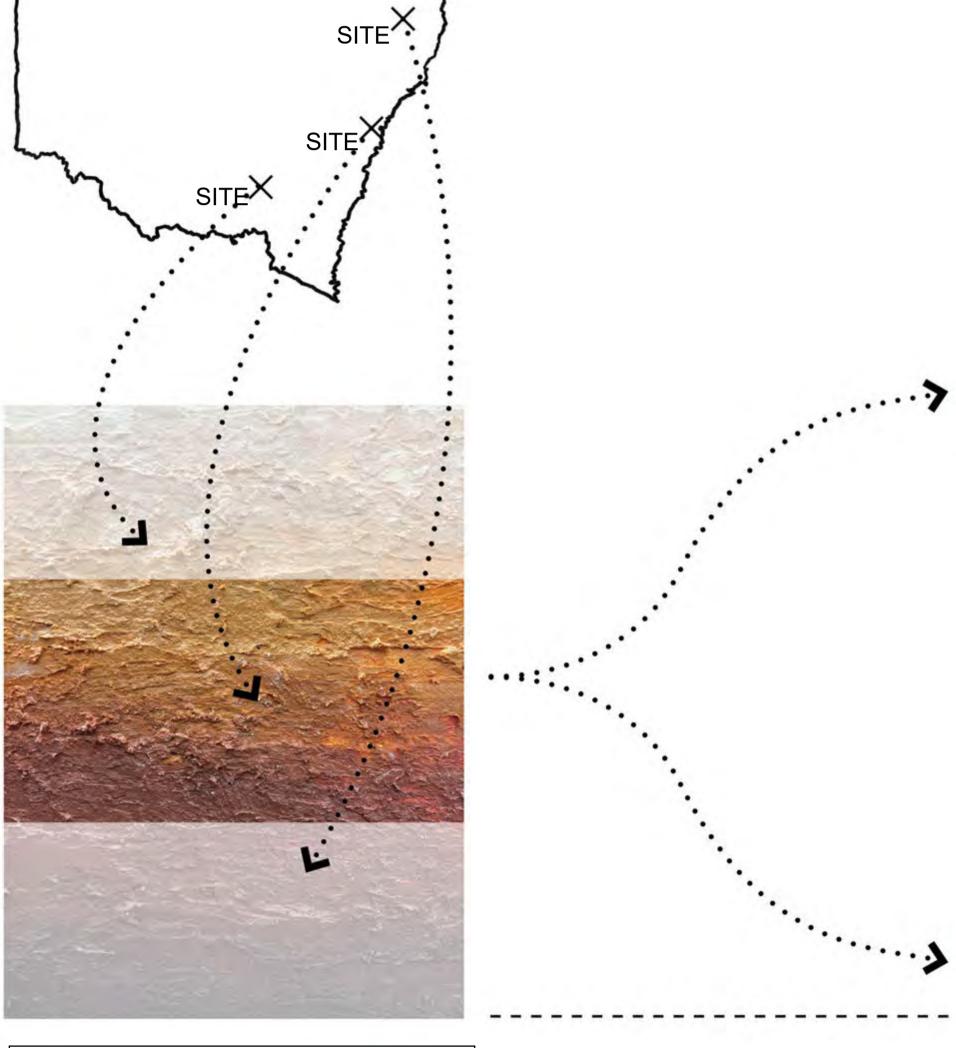

COUNTRY:
Project's colour scheme is informed by the Country where the project is situated.

UPPER:


Levels 1-3 materiality employs lighter tone of Country colour, with the exception of metalwork.

There should be an

upper material

approximate colour difference

of 50% between base and

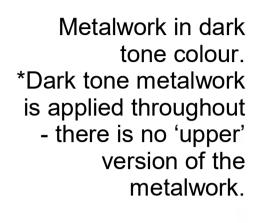





Primary Material:
Brick with colour-matched mortar or,
CFC Sheet. Light tone of Country colour

Find the local colours of Country and adapt the


NSW Government's eSPADE soil map index

comprises a statewide dataset of soil profiles,

colour palette according to the strategy as shown.

How to use

freely availble to view.

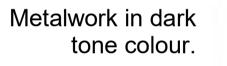



Off-form concrete



Primary Material : Brick with colour-matched mortar or,

Dark tone: Painted concrete

mortar or, CFC Sheet. Dark tone of Country colour

BASE:

Ground floor materiality employs darker tone of Country colour

NSW HOUSING PATTERN BOOK



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Country				
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8905 7100	Reception	@Nguluway.designinc.com.au		
nated Arc	chitects			
nstrong	7260	Cathryn Drew-Bredin	7269	
(erslake	7789	Mary Anne McGirr	10946	

Pattern Code	SLA02
Name	Small Lot Apartments 02
	by Nguluway DesignInc


Drawing No.	A-380
Name	MATERIAL PALETTE


GUIDE

NTS


Scale

BRICK PALETTE

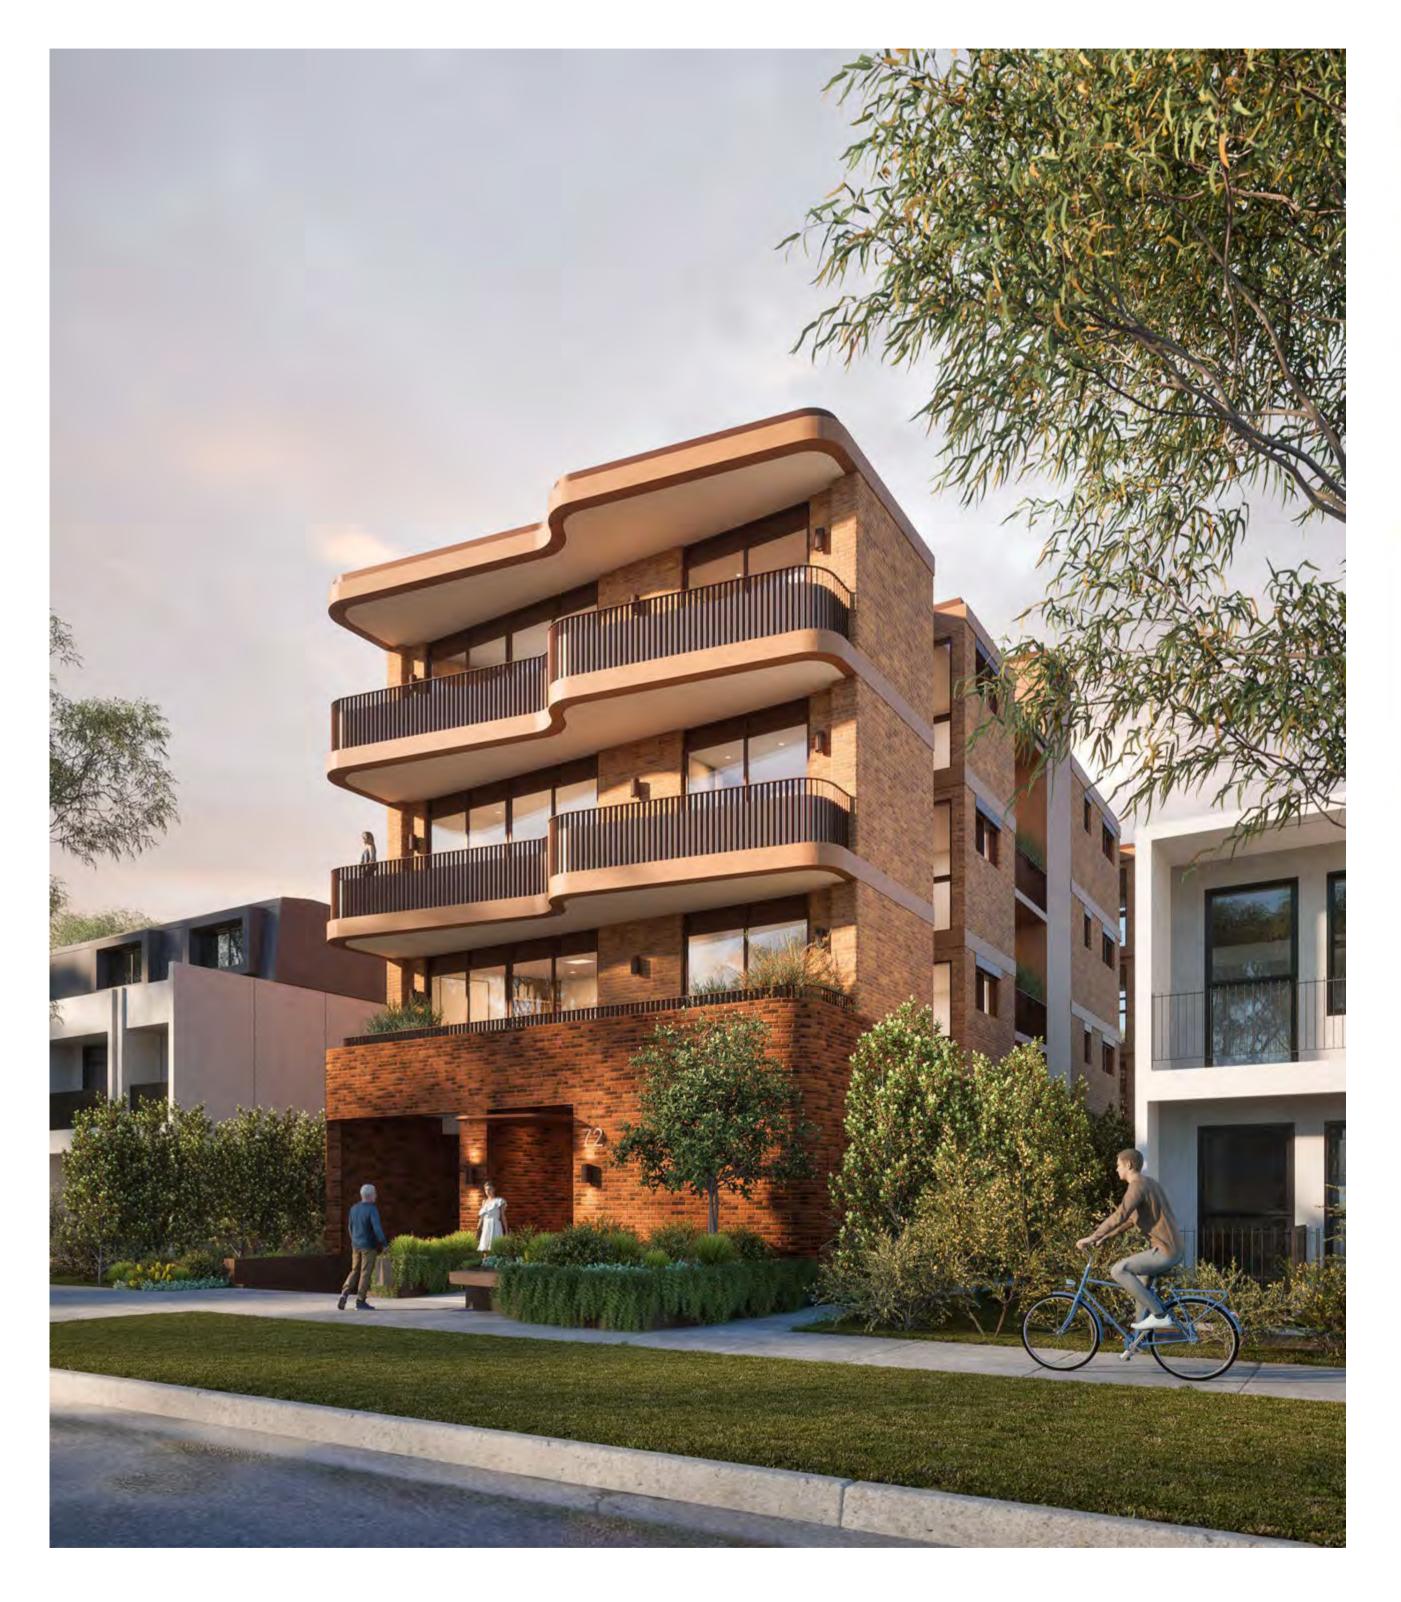

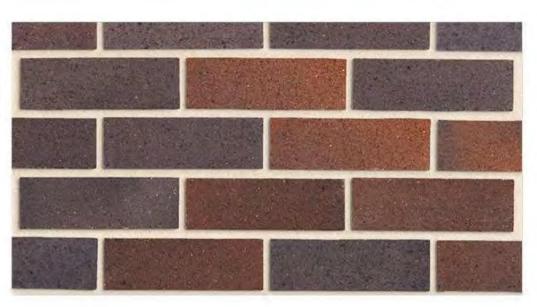

WF1 - Brick walls Face brick - darker base Colour-matched mortar

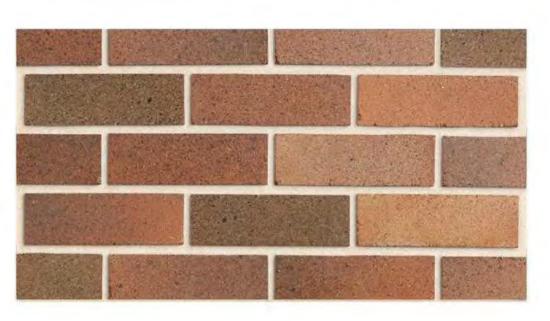

WF2 - Brick walls Face brick - lighter top Colour-matched mortar



WF3 - Concrete Planter beds, lift core, slab edges base Paint finish - earthy red colour




WF4 - Concrete Slab edges upper levels Paint finish - light earth colour



MW1 - Metalwork Aluminium powdercoat finish - dark red

(match to window framing)

WT1 - Window/door frames Aluminium powdercoat finish - dark red (match to metalwork)

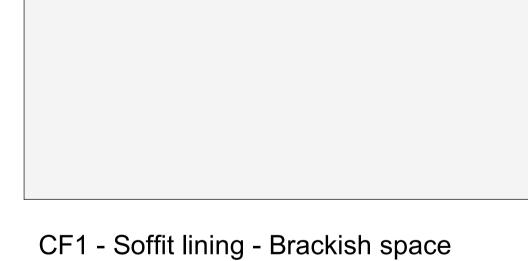

CFC sheet Paint finish - white

WF5 - Balcony slab underside Textured paint skim-coat Paint finish - white

NSW HOUSING PATTERN BOOK

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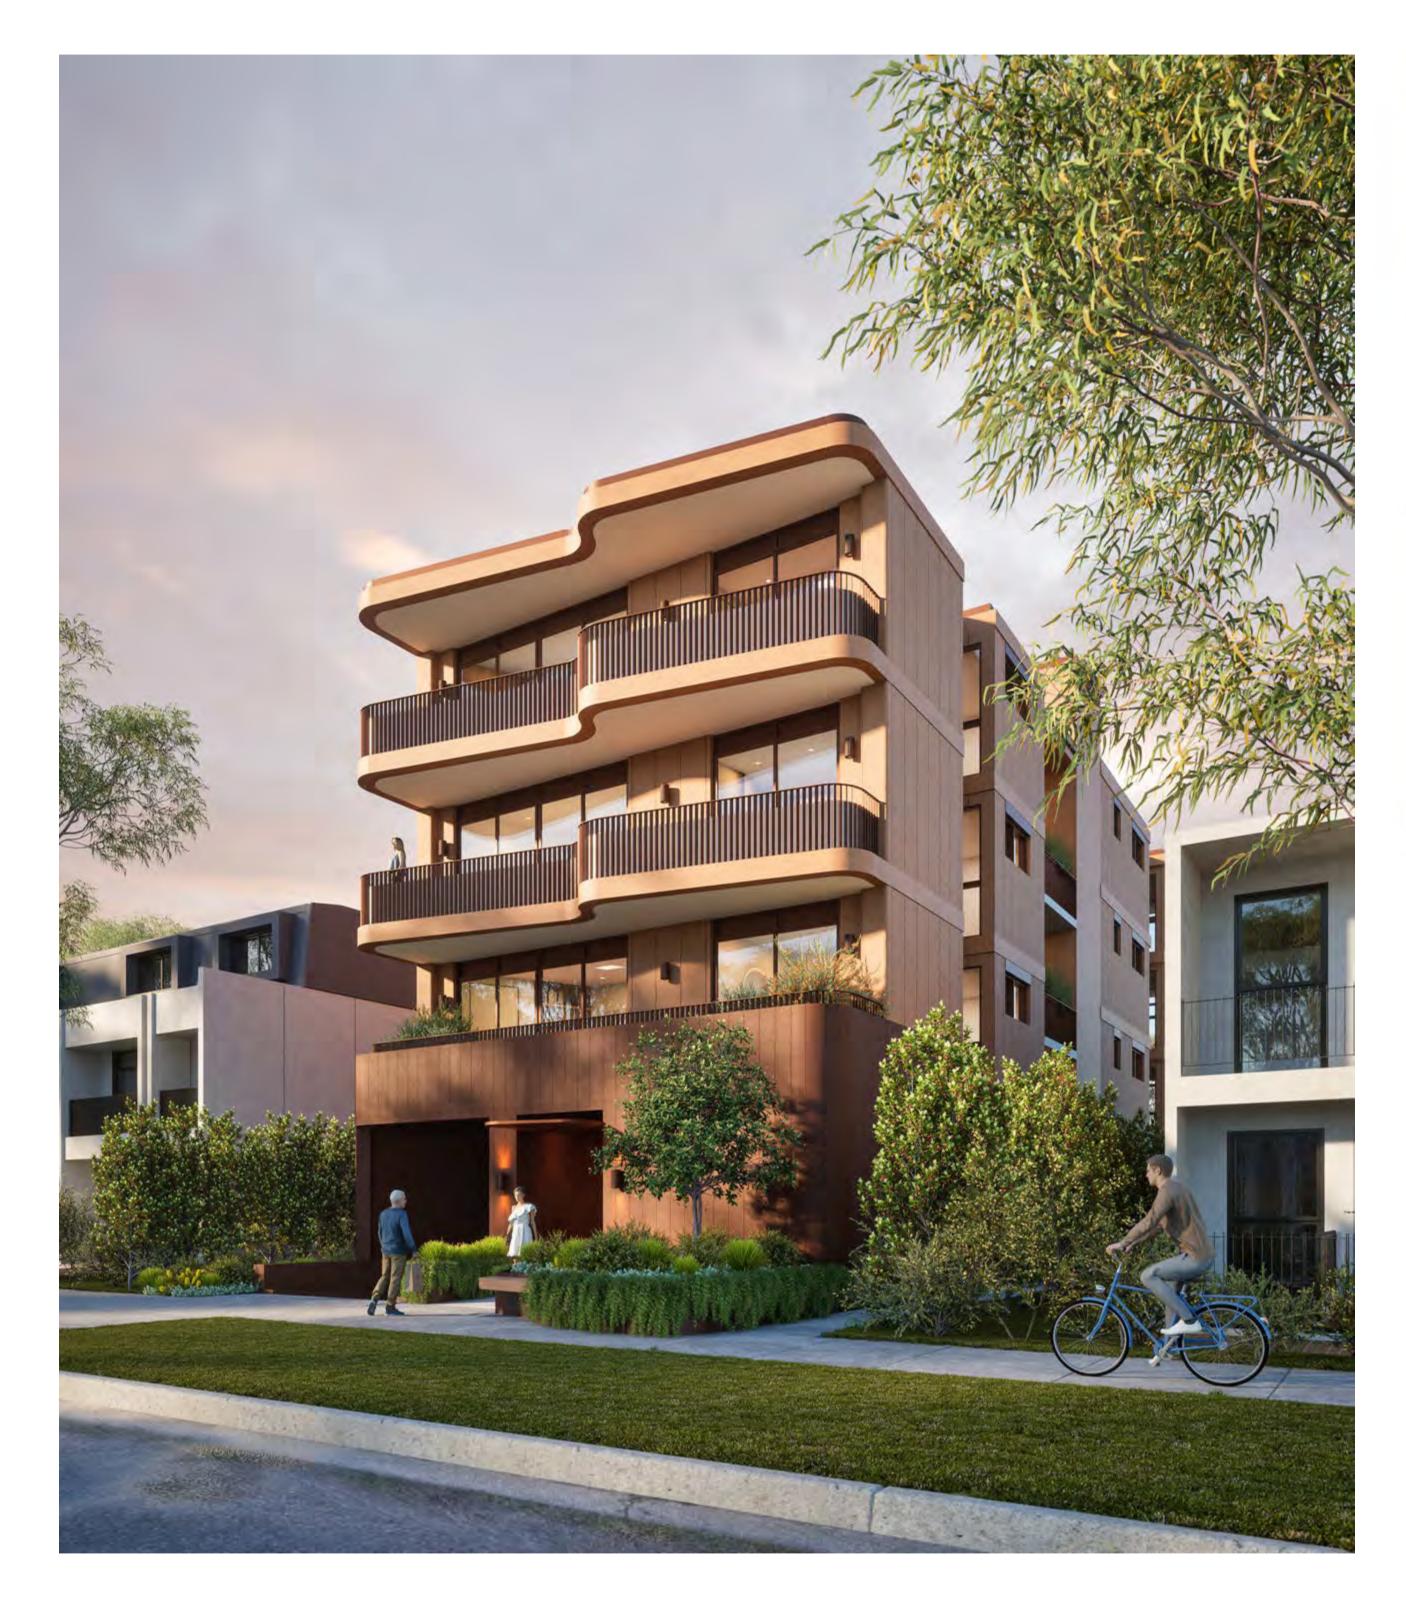
Pattern Code	SLA02
Name	Small Lot Apartments 02

by Nguluway DesignInc

A-381 Drawing No.

MATERIALS PALETTE Name

NTS Scale





WF1 - CFC cladding Darker base




WF2 - CFC cladding Lighter top



WF3 - Concrete Planter beds, lift core, slab edges base Paint finish - earthy red colour




WF4 - Concrete Slab edges upper levels Paint finish - light earth colour

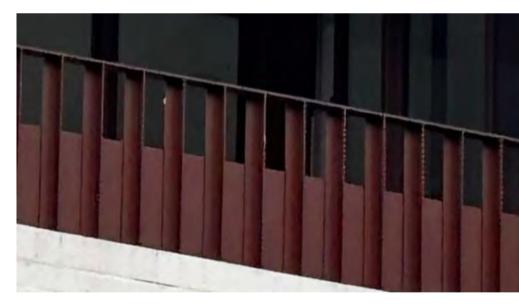

MW1 - Metalwork Aluminium powdercoat finish - dark red (match to window framing)

WT1 - Window/door frames Aluminium powdercoat finish - dark red (match to metalwork)

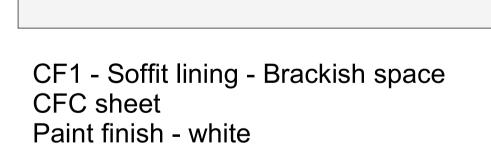

WF5 - Balcony slab underside Textured paint skim-coat Paint finish - white

NSW HOUSING PATTERN BOOK

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Gadigal Country Level 12, 126 Phillip Street, Sydney NSW 2000

Name

SLA02 Pattern Code **Small Lot Apartments 02** by Nguluway DesignInc

A-382 Drawing No. Name

MATERIALS PALETTE

NTS Scale



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din 7269 1094 Pattern Code SLA02

Name Small Lot Apartments 02
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Drawing No.


Name

RENDERED VIEW 01

A-390



GOVERNMENT ARCHITECT NEW SOUTH WALES

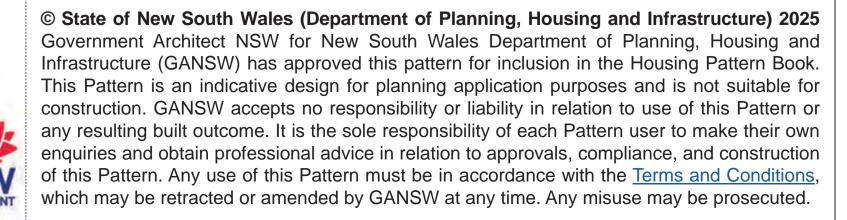

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Iominated Architects
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braig Kerslake 7789

lin 726 109 Pattern Code SLA02

Name Small Lot Apartments 02
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Drawing No.

A-391

Name RENDERED VIEW 02



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lan Armstrong 7260
Craig Kerslake 7789

Bredin 72 Girr 10 Pattern Code SLA02

Name Small Lot Apartments 02
by Nguluway DesignInc

Drawing No.

A-392

Name RENDERED VIEW 03







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Name

Small Lot Apartments 02 by Nguluway DesignInc

Drawing No.

Name

A-393

RENDERED VIEW 04



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ominated Architects
n Armstrong 7260
aig Kerslake 7789

7269 10946 Pattern Code SLA02

Name Small Lot Apartments 02
by Nguluway DesignInc


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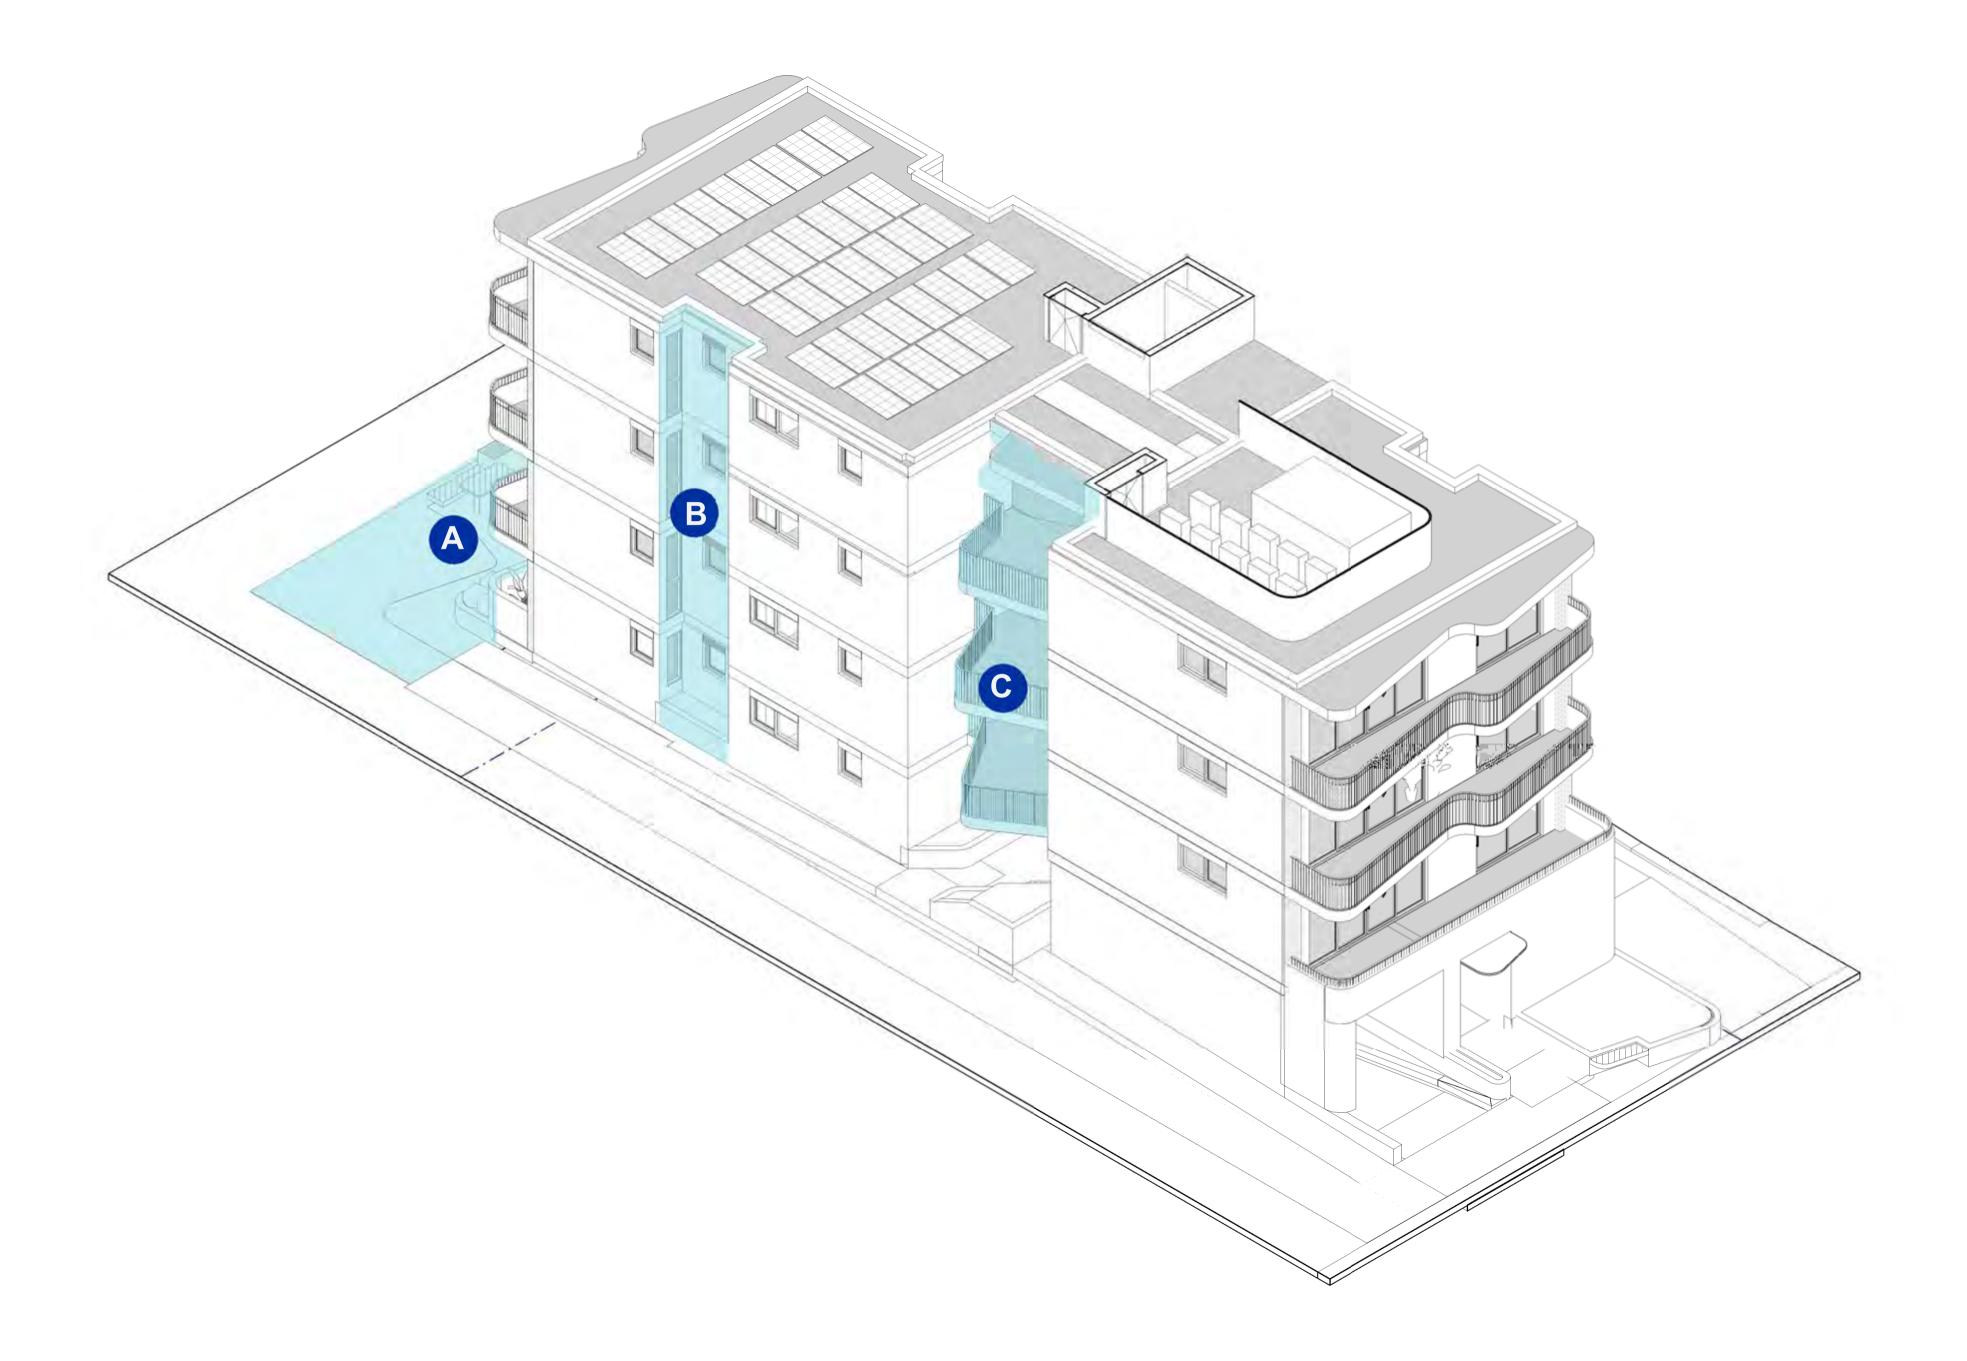
Name RENDERED VIEW 05


NSW Housing Pattern Book

SMALL LOT APARTIMENTS 02 by Nguluway DesignInc

Technical information



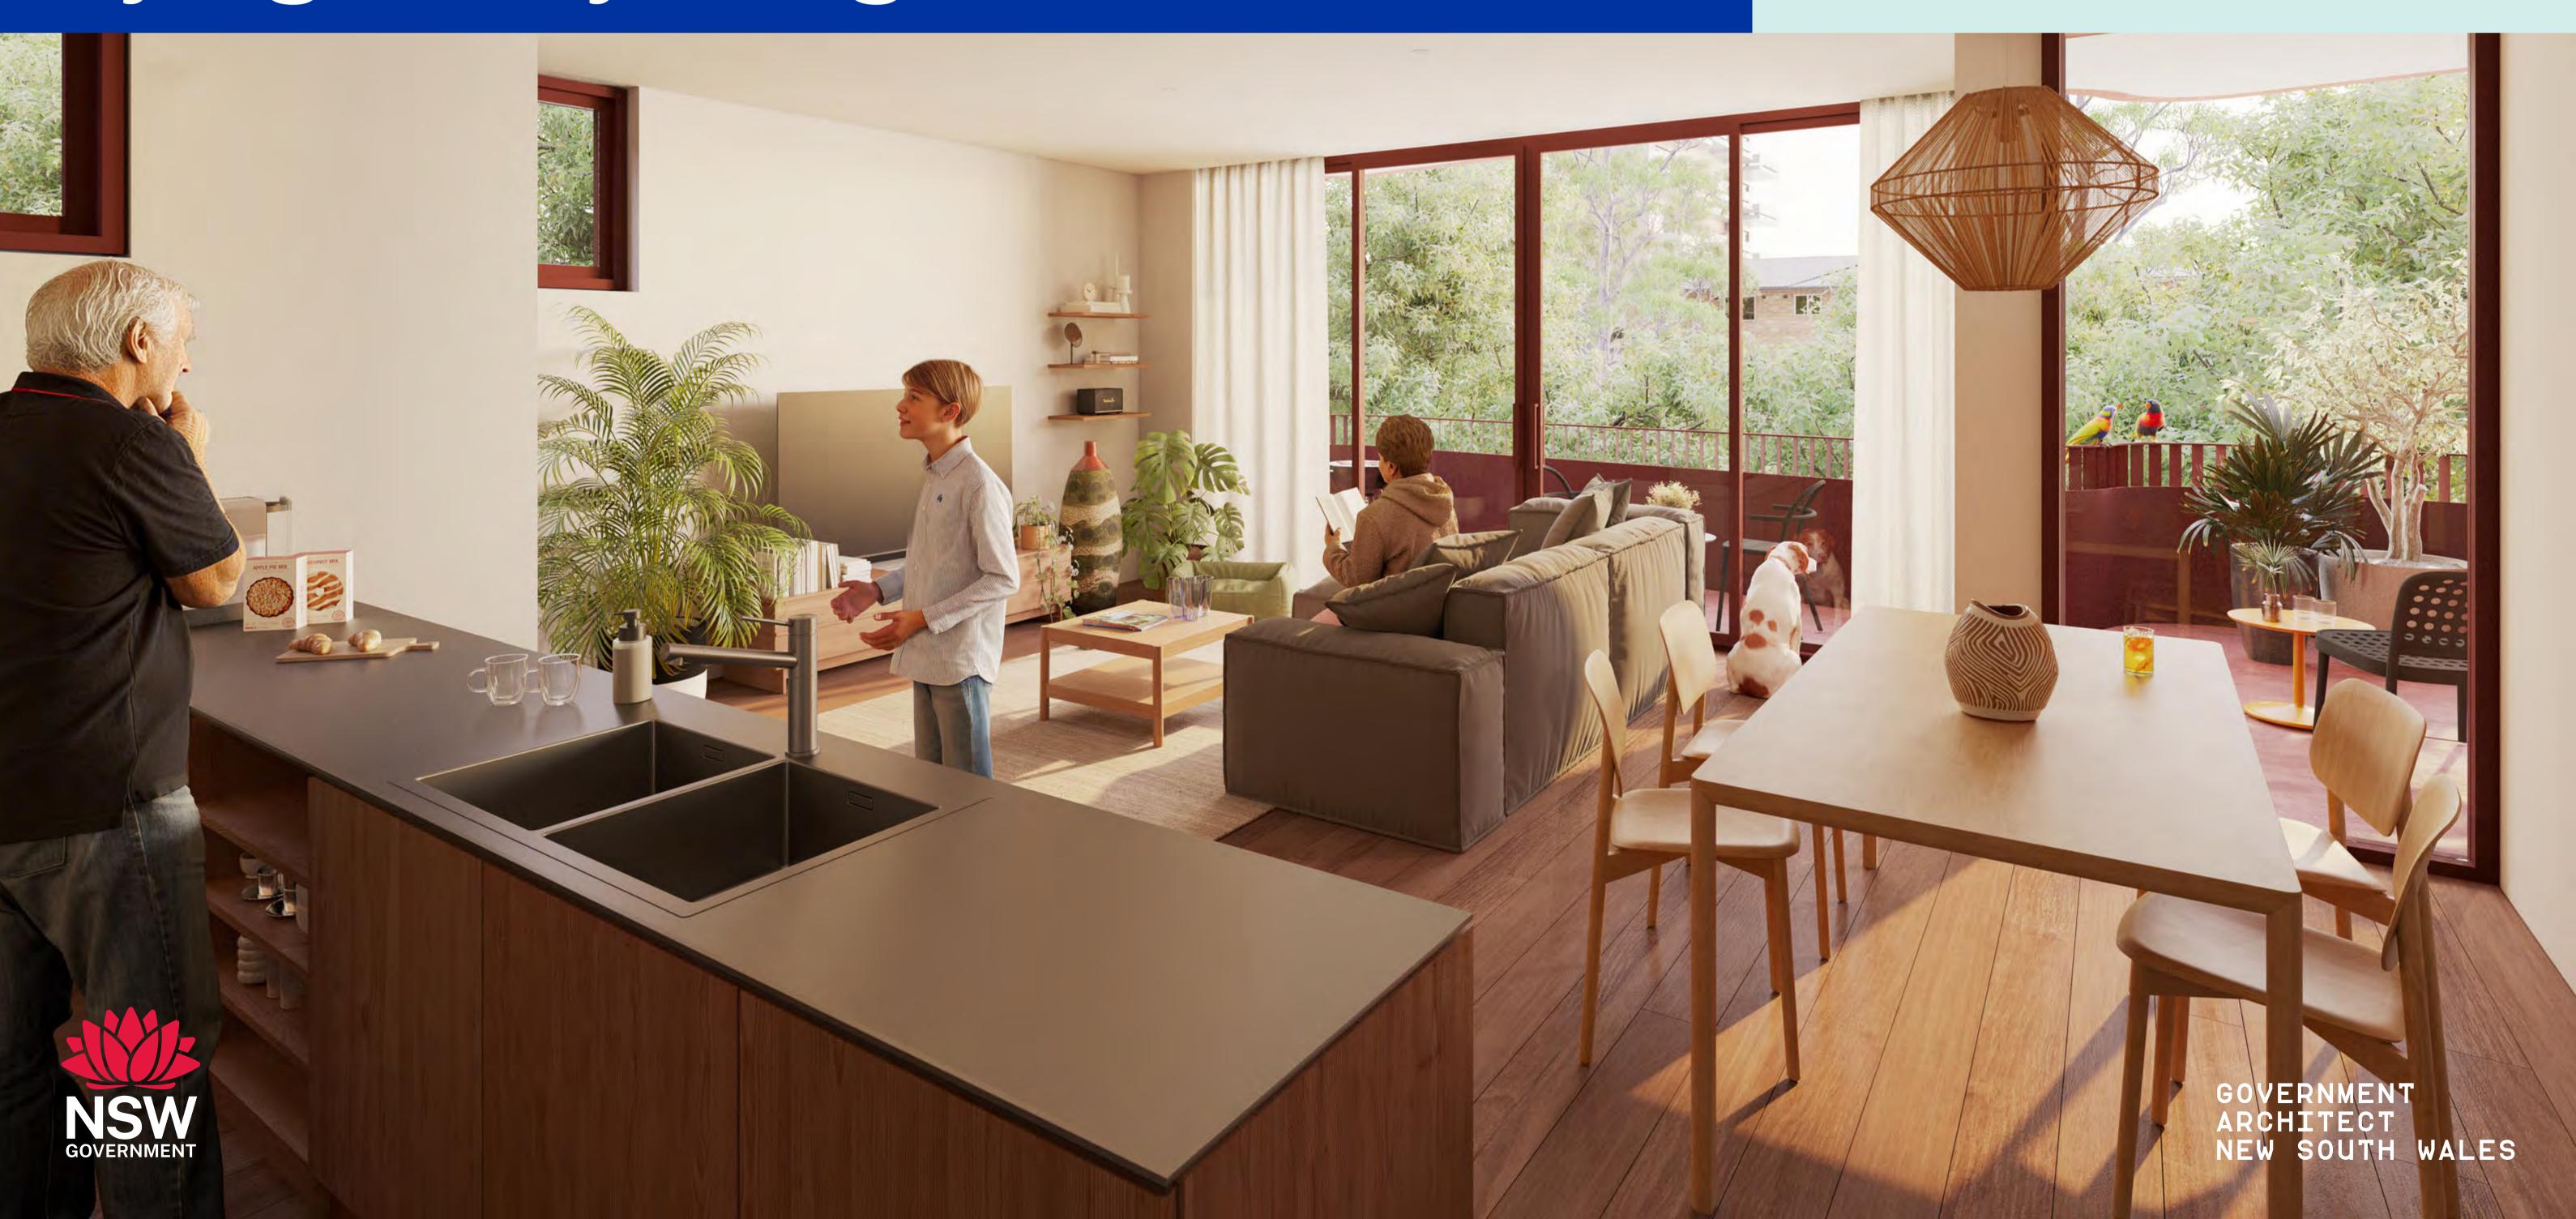

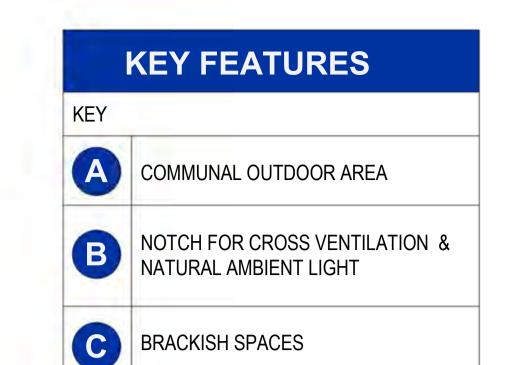

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minated Architects
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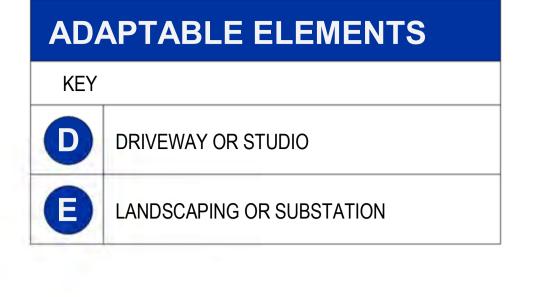
Cathryn Drew-Bredin Mary Anne McGirr Pattern Code SLA02


Name Small Lot Apartments 02
by Nguluway DesignInc

Drawing No.

A-395

Name ILLUSTRATIVE
AXONOMETRIC VIEW –
KEY FEATURES



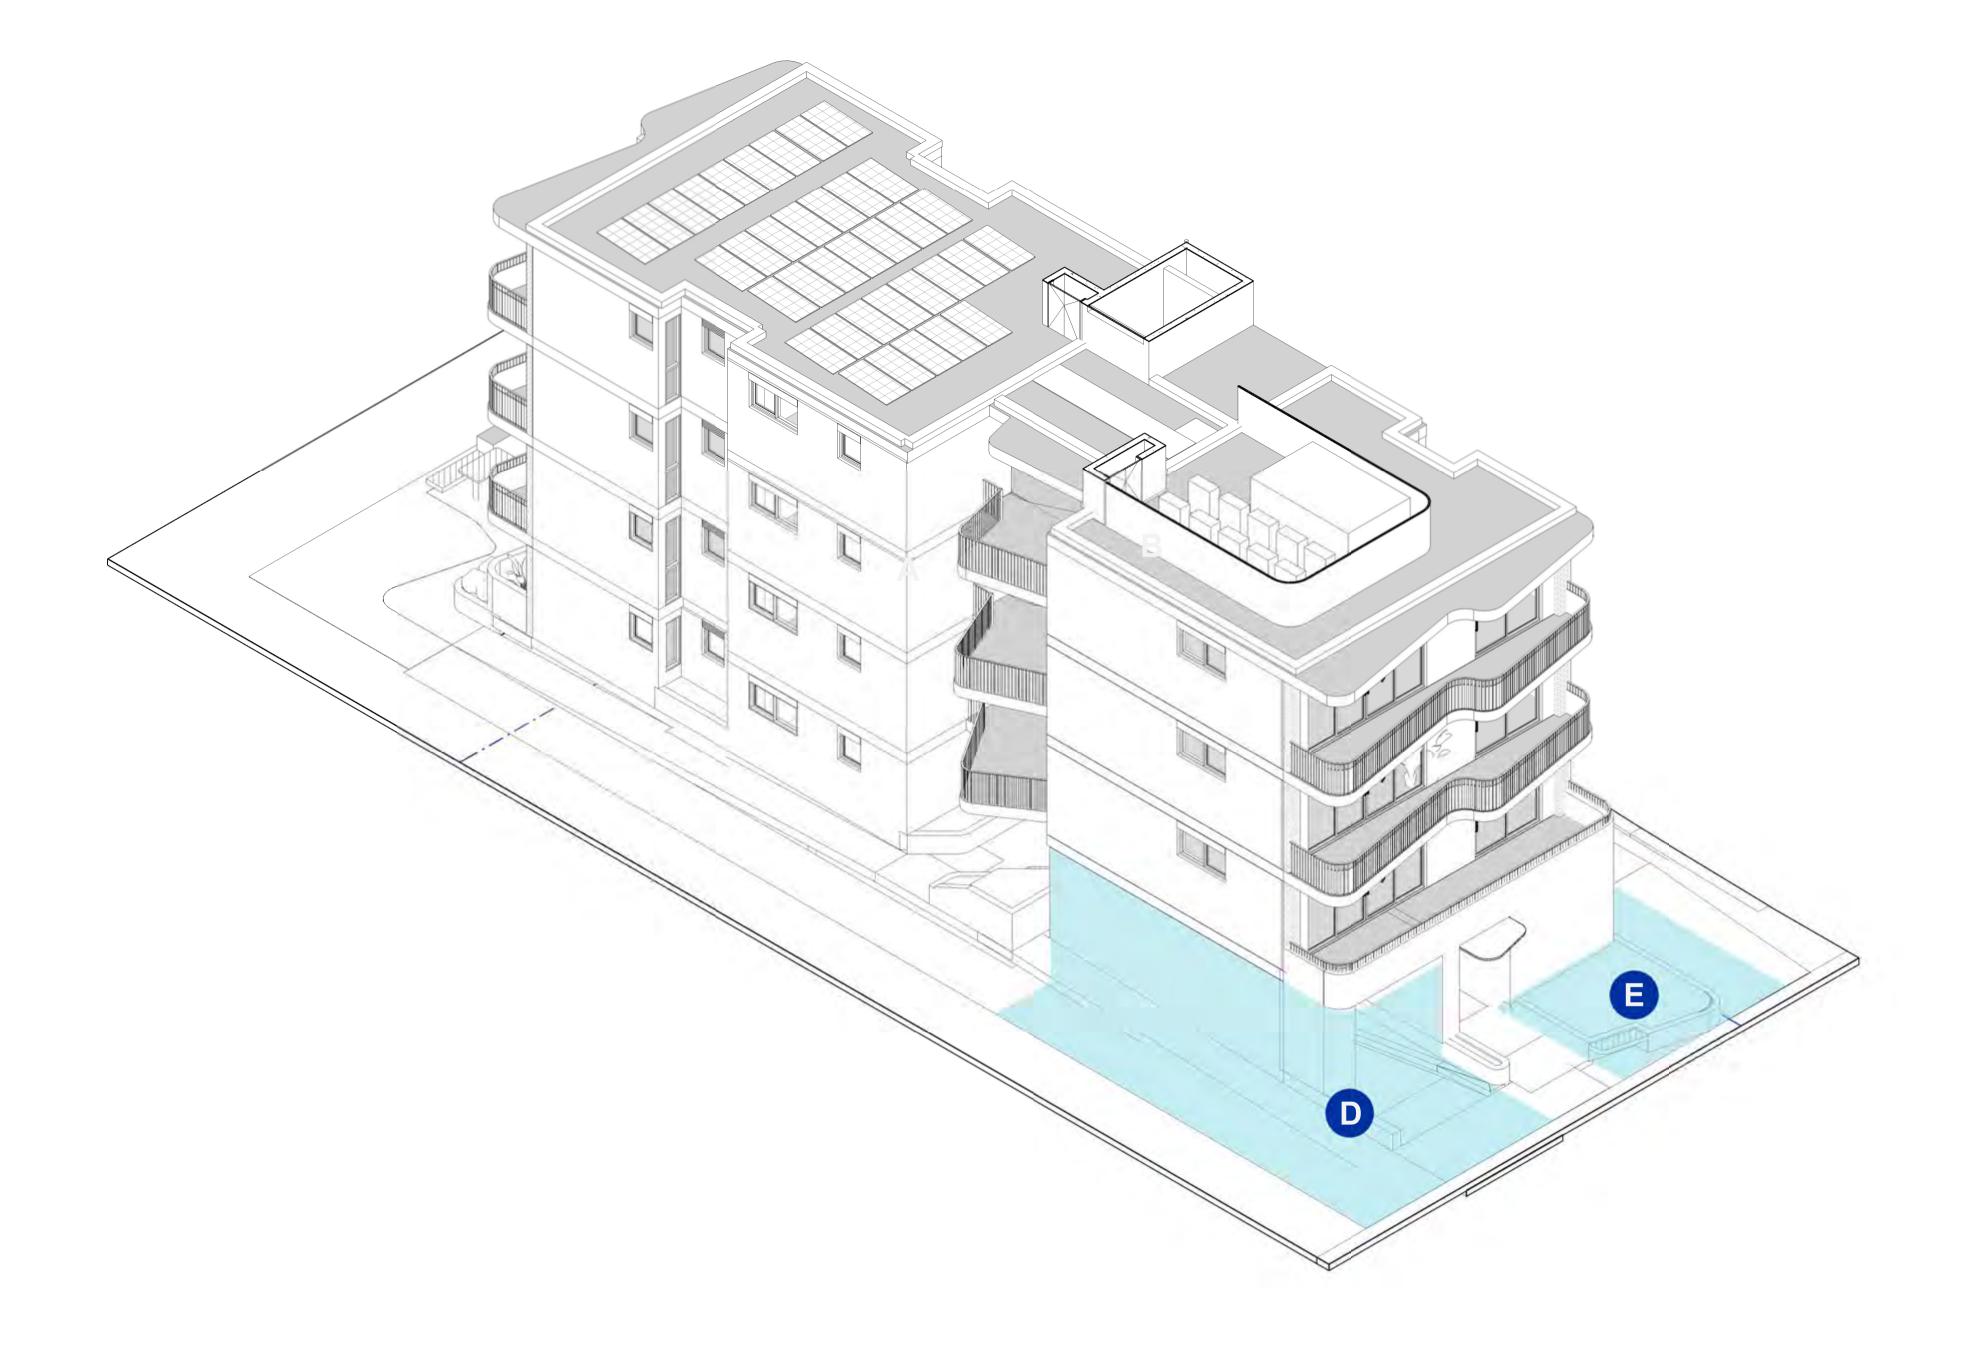

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Name

Pattern Code

SLA02

Small Lot Apartments 02 by Nguluway DesignInc

Drawing No.


Name

A-396


LLUSTRATIVE AXONOMETRIC VIEW – ADAPTABLE FEATURES

NTS Scale

Services

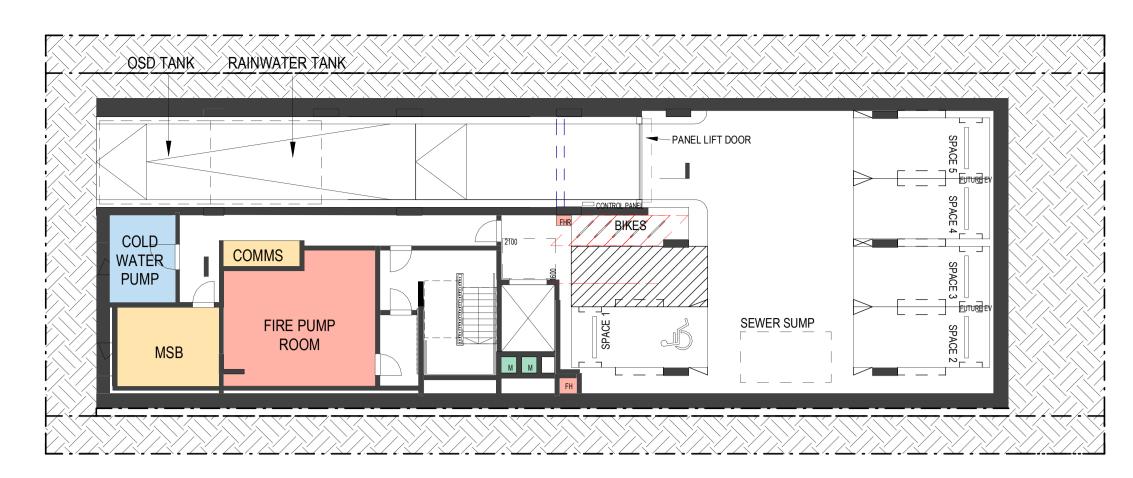




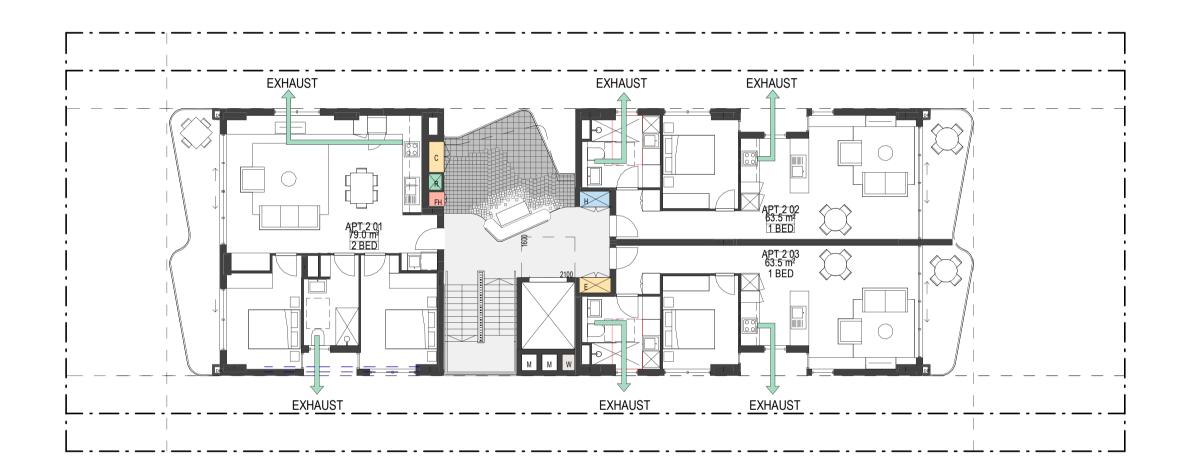


3 TYPICAL UPPER FLOOR PLAN



2 GROUND FLOOR PLAN

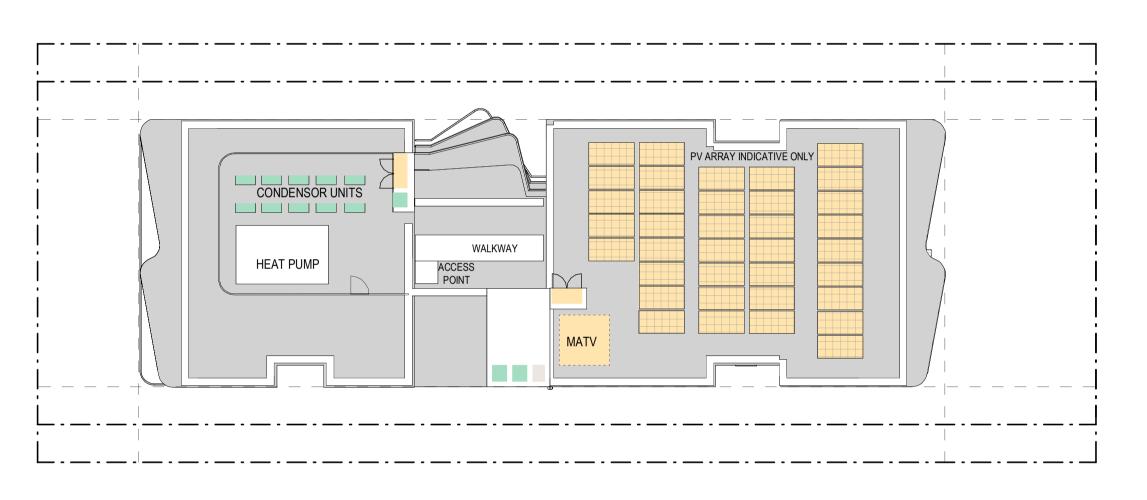

4 ROOF PLAN

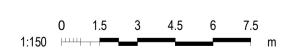

AS INDICATED @ A1

NSW HOUSING PATTERN BOOK

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	Nominated Arcl	<u>hitects</u> 7260	Cathryn Drew-Bredin	7269

Pattern Code	SLA02
Name	Small Lot Apartments

Small Lot Apartments 02	Name	5
by Nguluway DesignInc		

Scale

Drawing No.

SERVICES

ELECTRICAL/COMMS

MECHANICAL

HYDRAULIC

FIRE

WASTE

COMMS RISER

E | ELECTRICAL RISER

FH | FIRE HYDRANT

H HYDRAULIC RISER

FIP FIRE INDICATOR PANEL


MECHANICAL RISER

WASTE ROOM RISER


AC REFRIGERANT RISER

SERVICES DIAGRAM


A-400

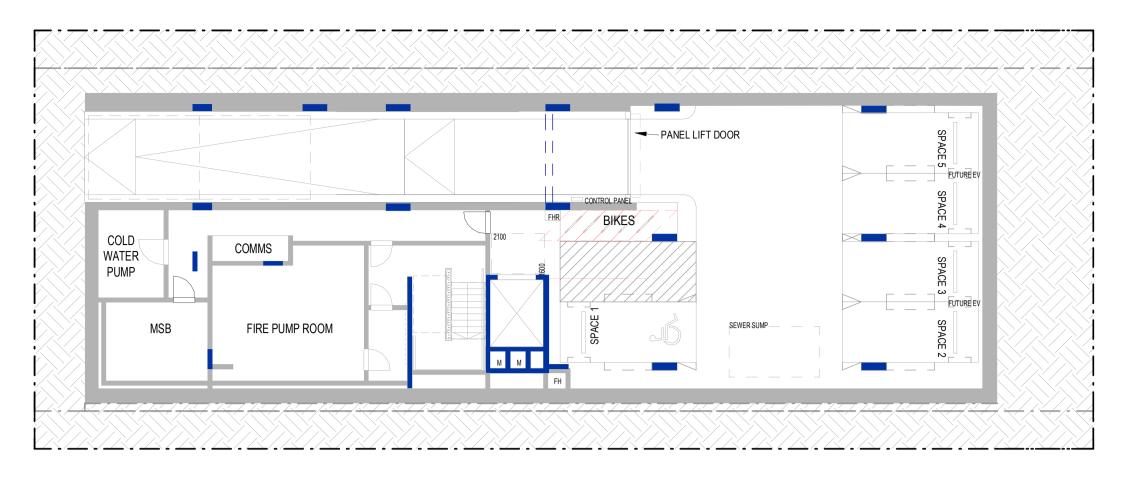




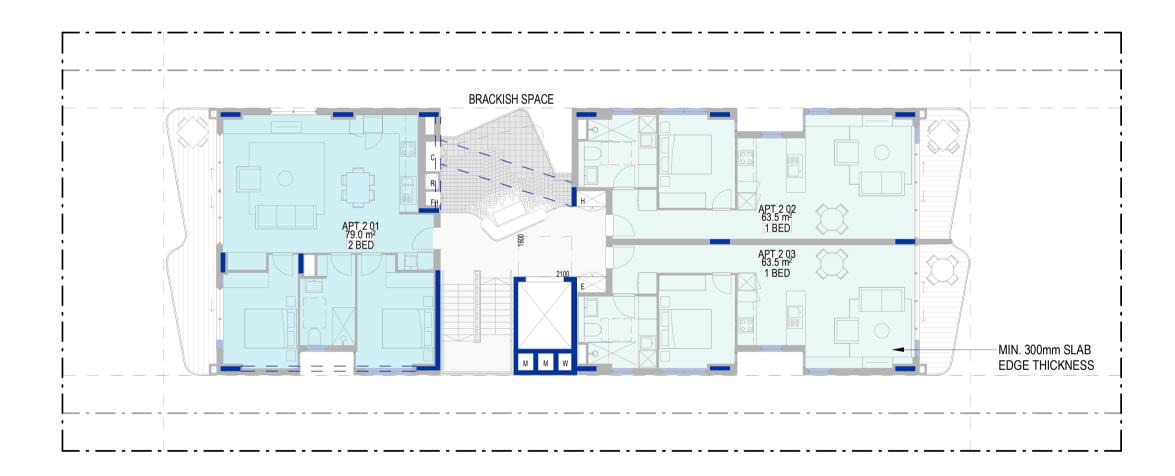

3 TYPICAL UPPER FLOOR PLAN

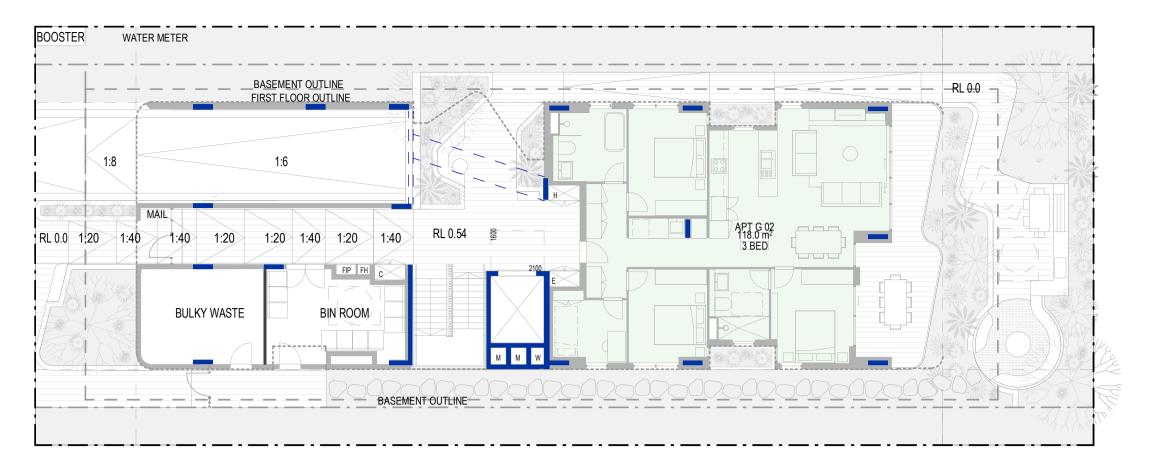

2 GROUND FLOOR PLAN

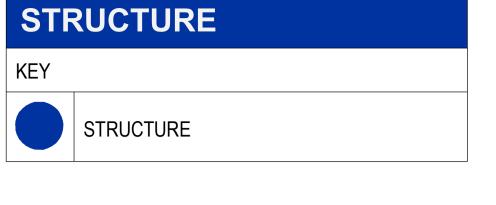

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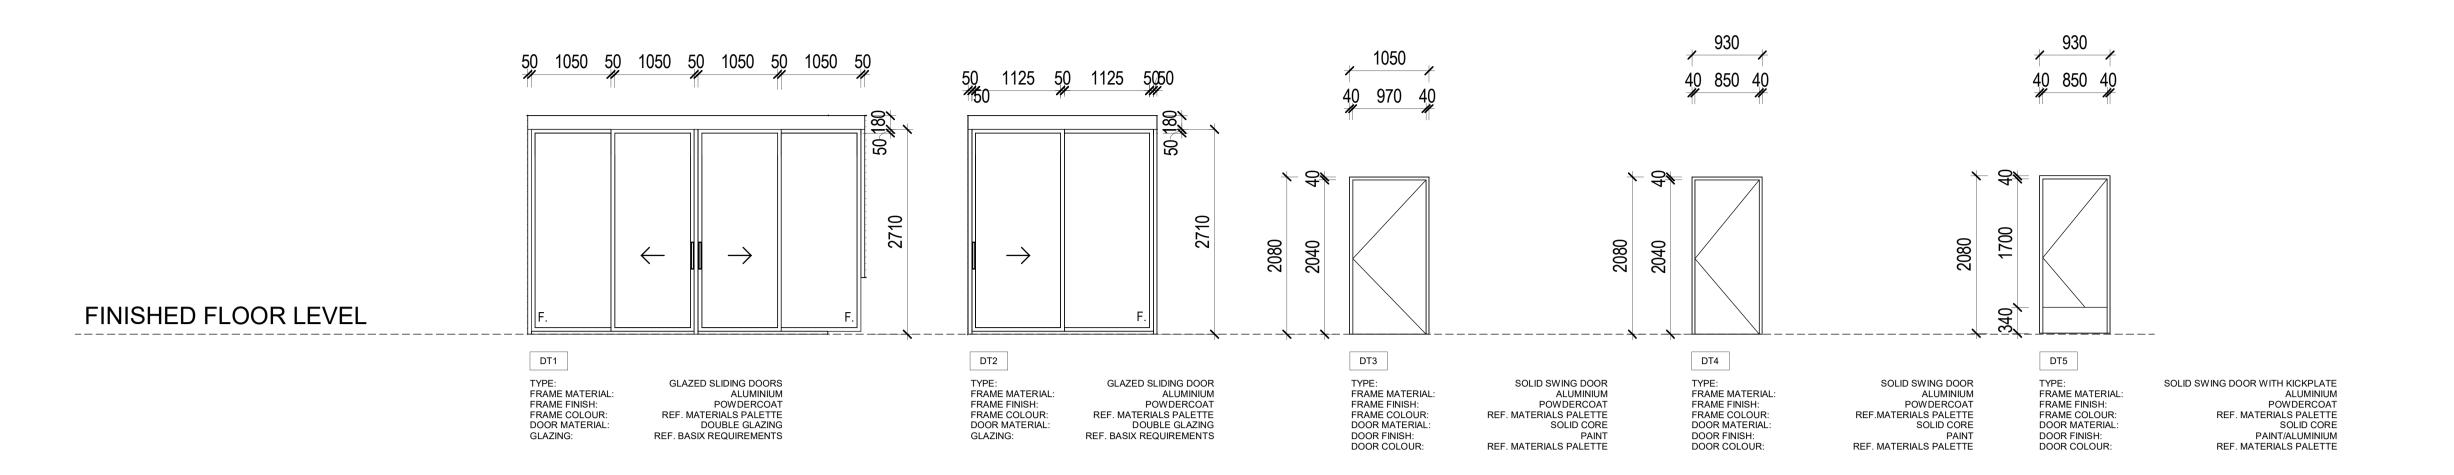
Date	Description
Nov 2025	Pattern Book Issue


NGU	LUWAY DesignInc
Gadigal Country	•
,	reet, Sydney NSW 2000
+61 2 8905 7100	Reception@Nguluway.designinc.com.au

rawing No.	A-401
lame	STRUCTURE DIAGRAMS

Technical information

Window and door schedule



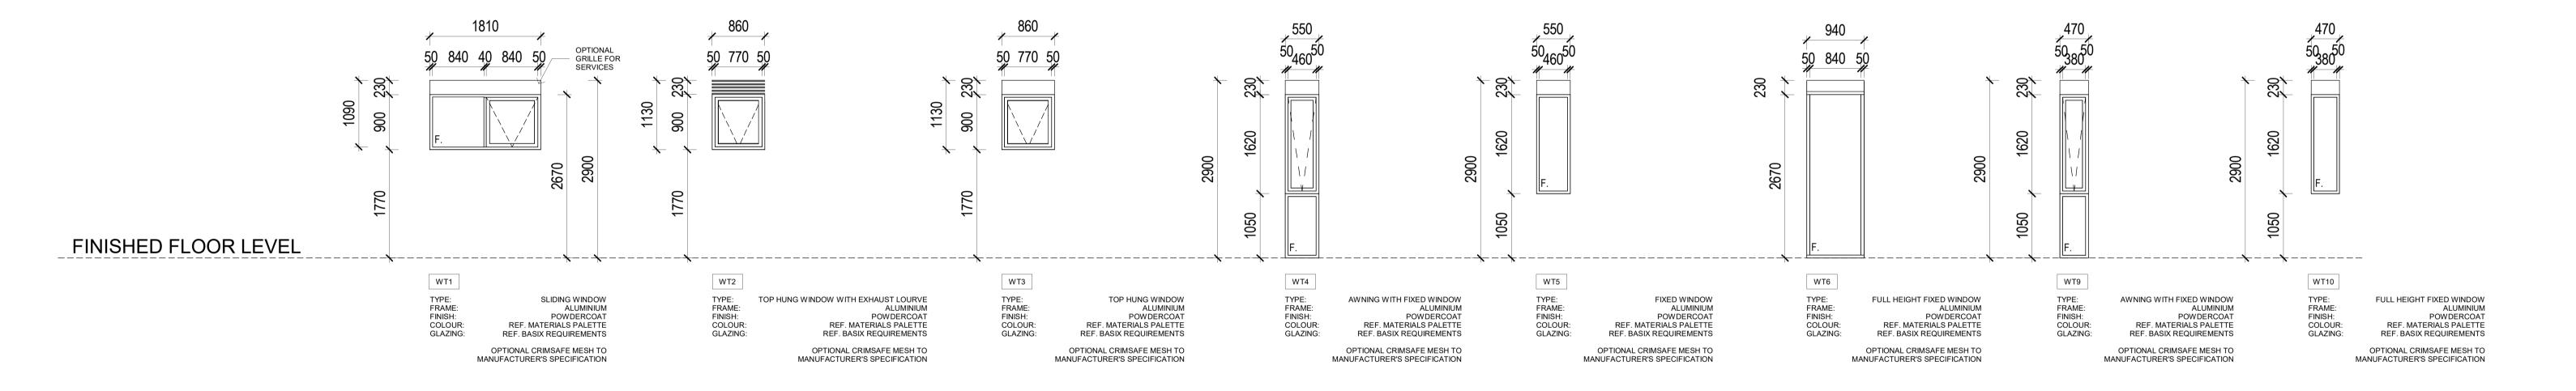

0 500 1000 1500 2000 2500 SCALE BAR - 1:50

NSW HOUSING PATTERN BOOK

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Nominated Architects

Cathryn Drew-Bredin

Mary Anne McGirr

Pattern Code	SLA02
Name	Small Lot Apartments 02
	by Nguluway DesignInc


Drawing No. A-410

Name WINDOW AND DOOR SCHEDULE

Scale 1:50 @ A1

Technical information

Details

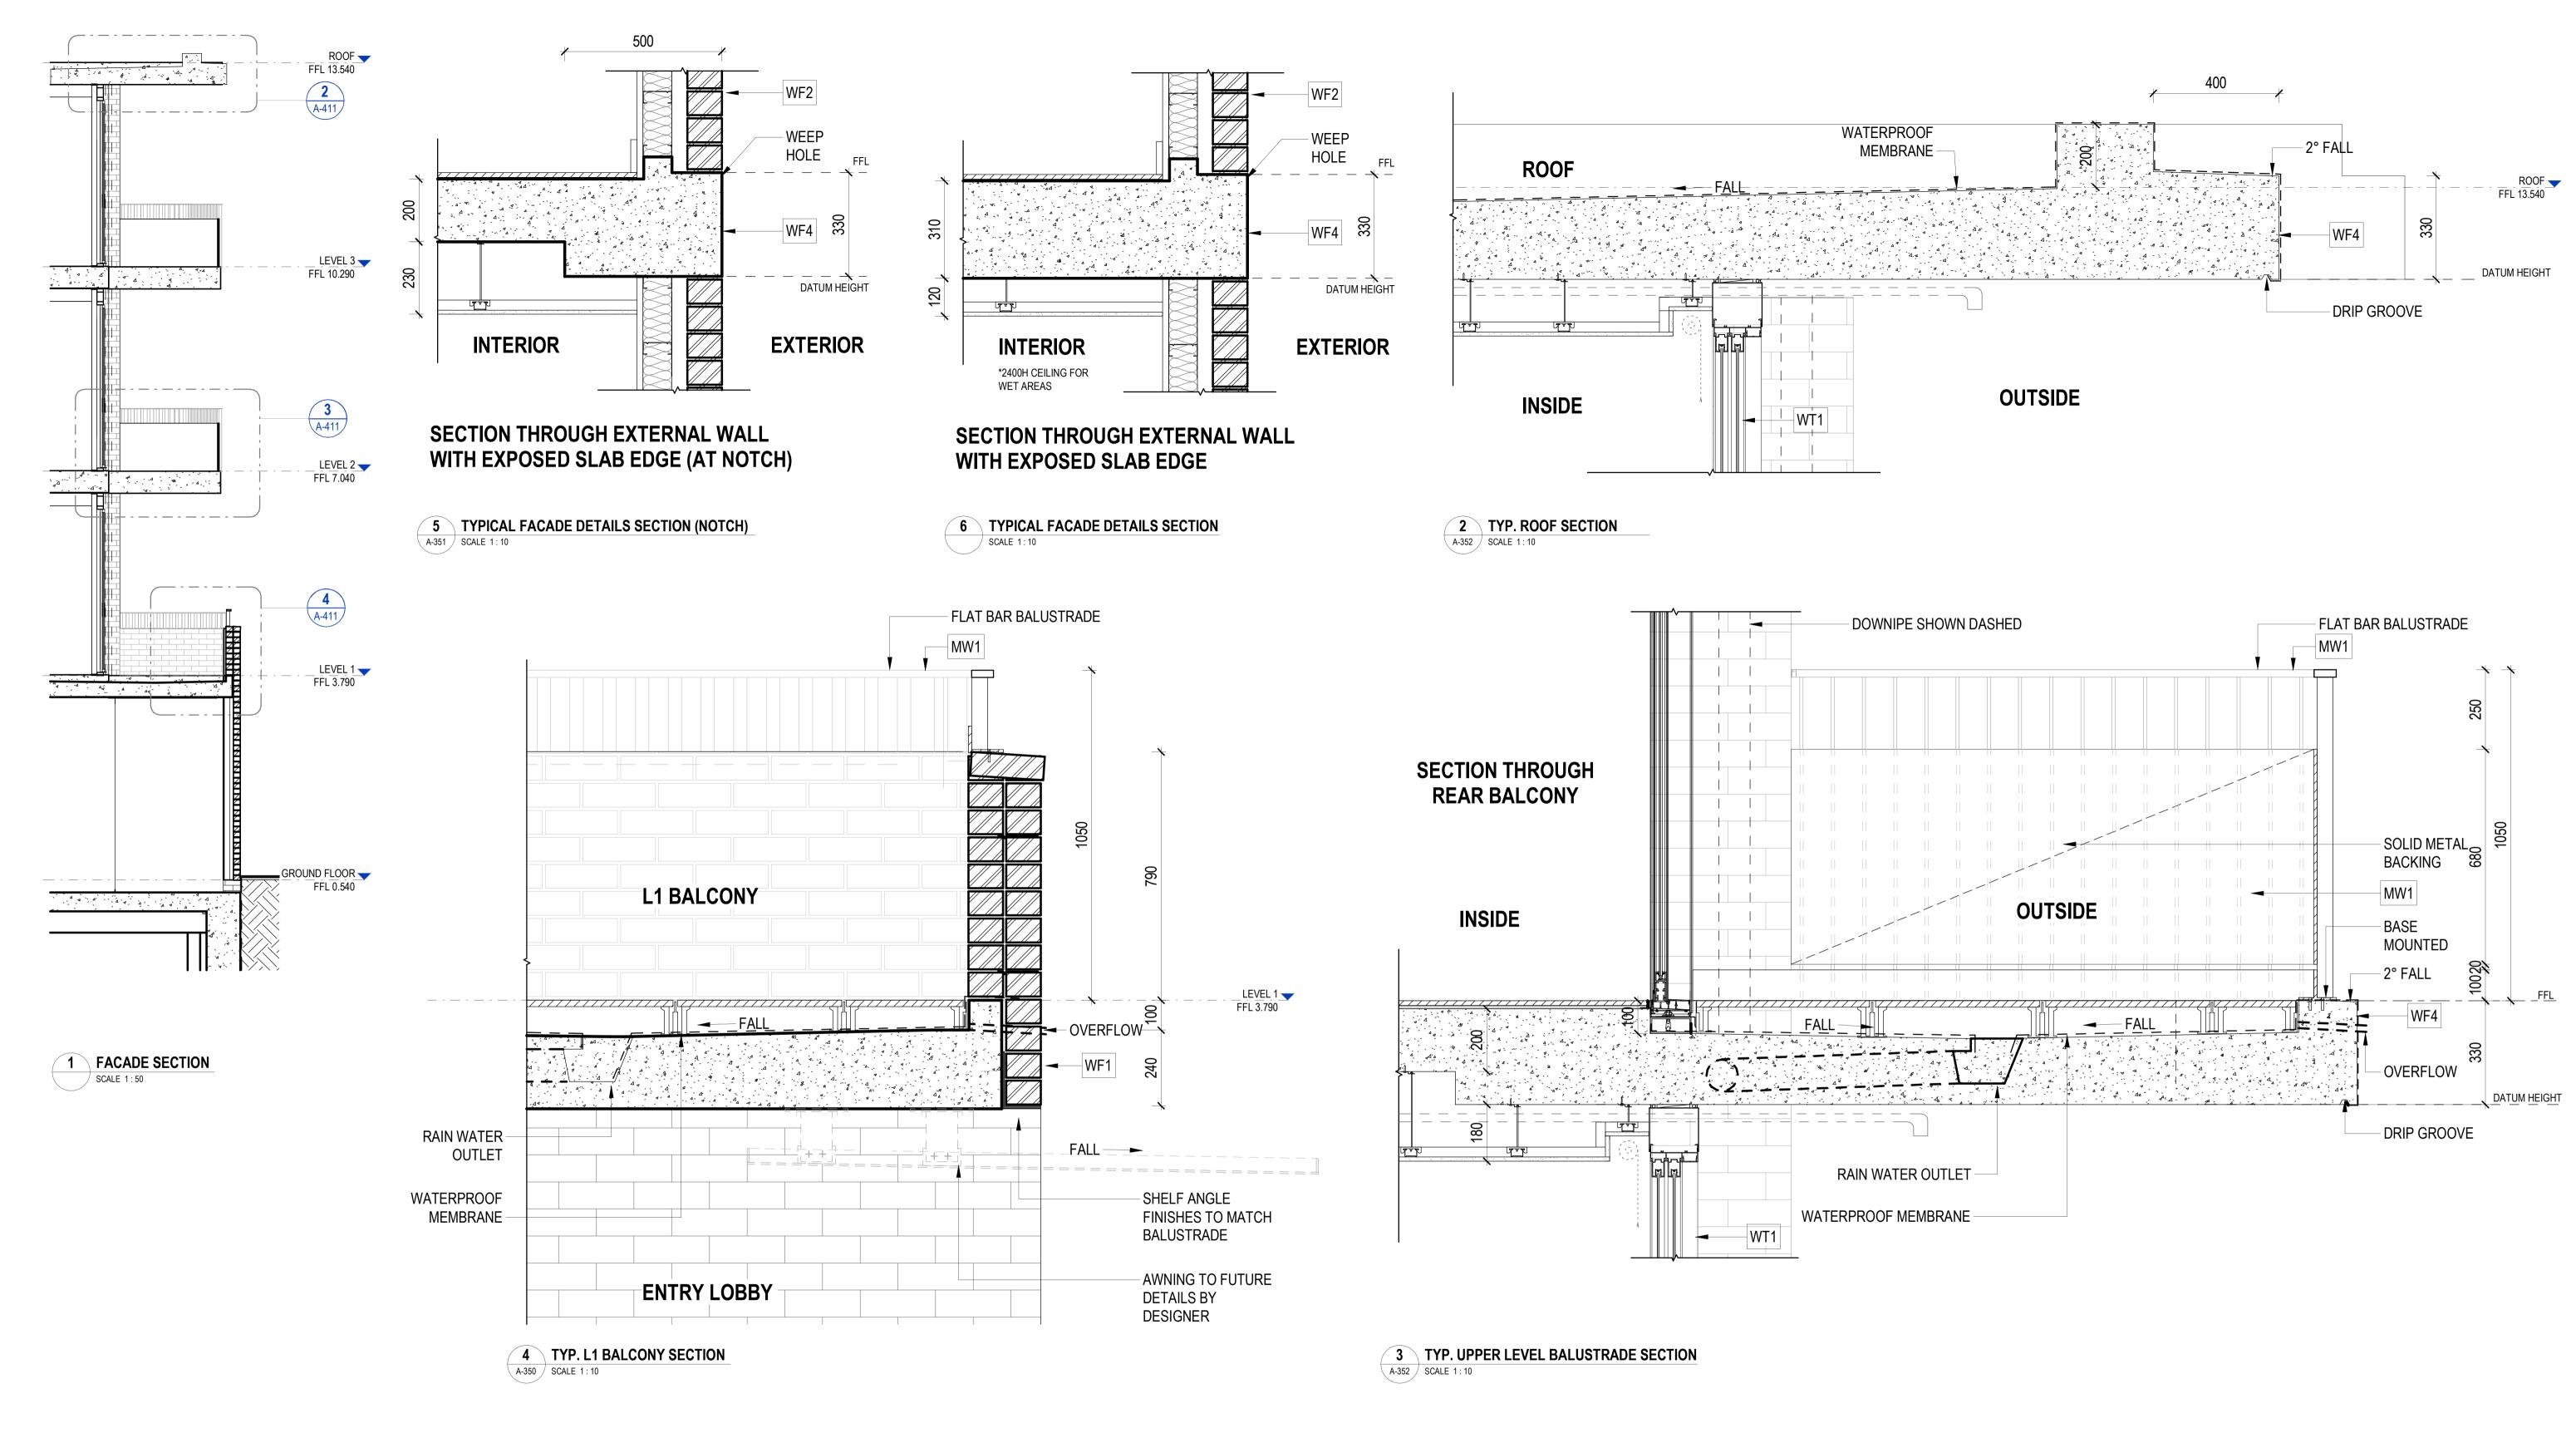

NOT FOR CONSTRUCTION. THESE DETAIL DRAWINGS ARE PRELIMINARY AND INDICATIVE ONLY, AND SUBJECT TO FURTHER AND DETAILED INPUT, DESIGN AND ADVICE BY THE PROJECT TEAM. THEY ARE INCLUDED TO SHOW THE DESIGN INTENT ONLY OF KEY ARCHITECTURAL FEATURES AND ARE NOT FOR CONSTRUCTION.

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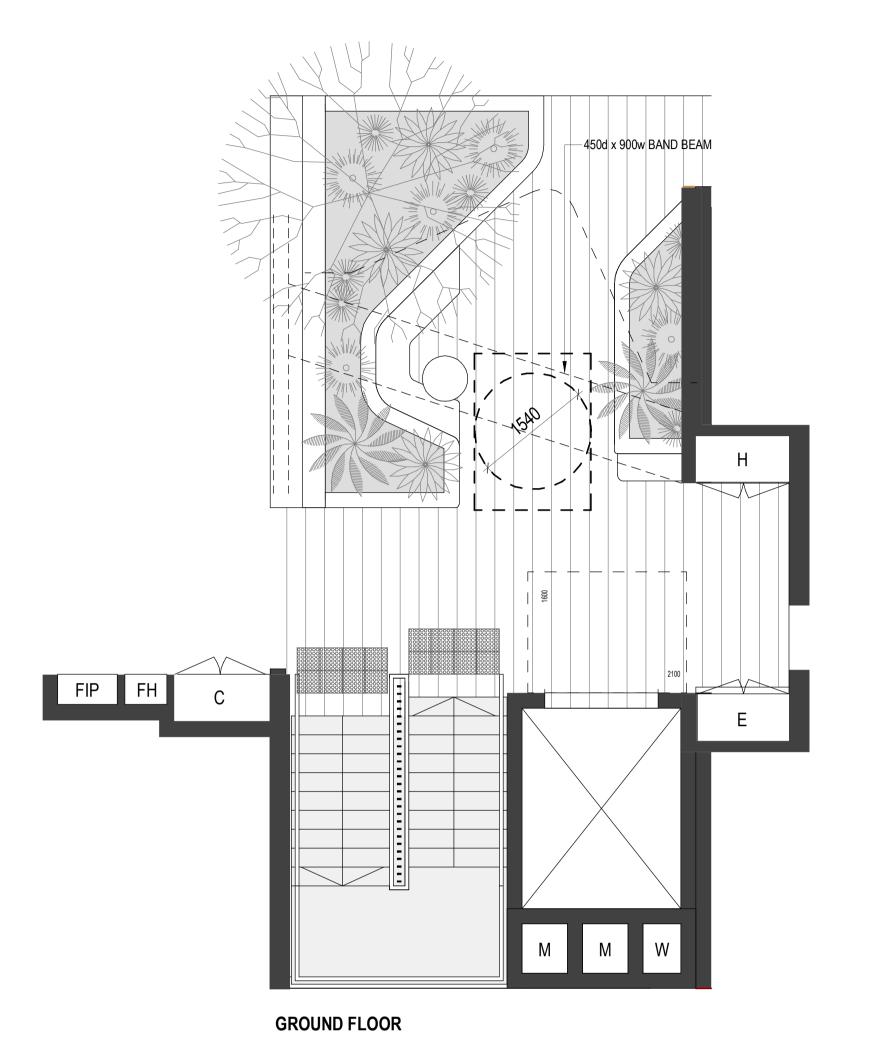
Rev	Date	Description	
Rev 1	Nov 2025	Pattern Book Issue	


_	NGU	LU	WAYDes	signInc
_	Gadigal Country Level 12, 126 Phillip +61 2 8905 7100		ISW 2000 @Nguluway.designinc.com.au	
	Nominated Arc	chitects 7260	Cathryn Drew-Bredin	7269
	Craia Karalaka	7700	Mary Anna MaCirr	10046


Pattern Code	SLA02	Drawing No.
Name	Small Lot Apartments 02 by Nguluway DesignInc	Name


Drawing No.	A-411
Name	KEY FACADE ELEMENT TYPES
Scale	AS INDICATED @ A1

KEY ---- CLEARANCE ZONE ---- FEATURE PAVING ZONE ---- FURNITURE ZONE



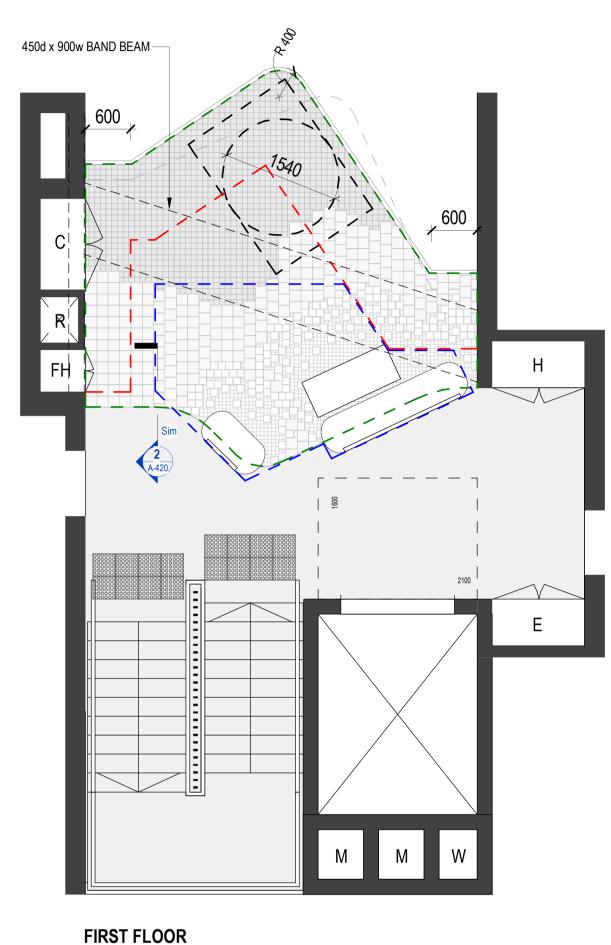

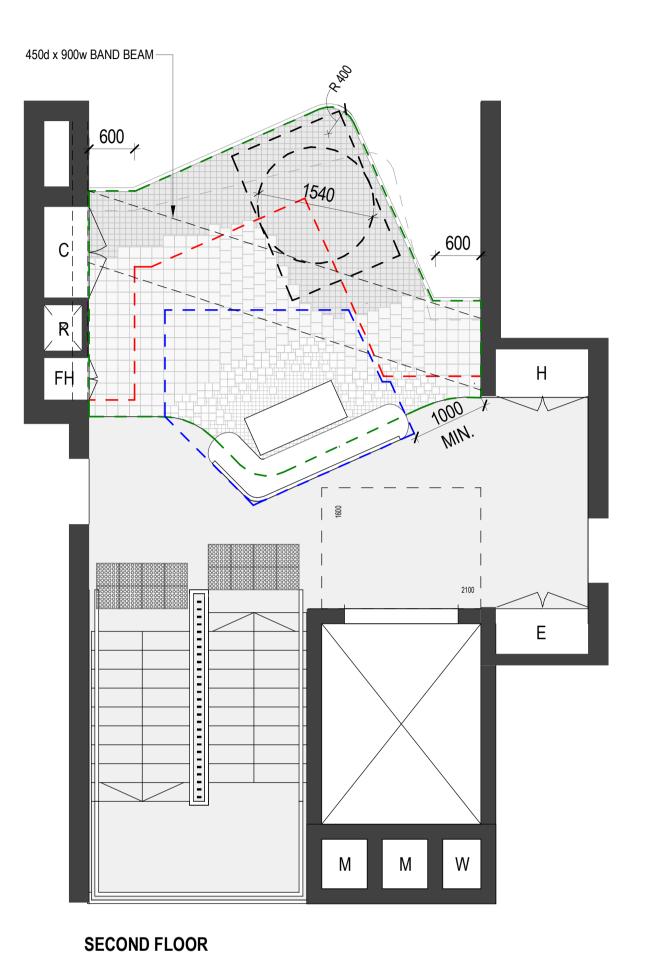

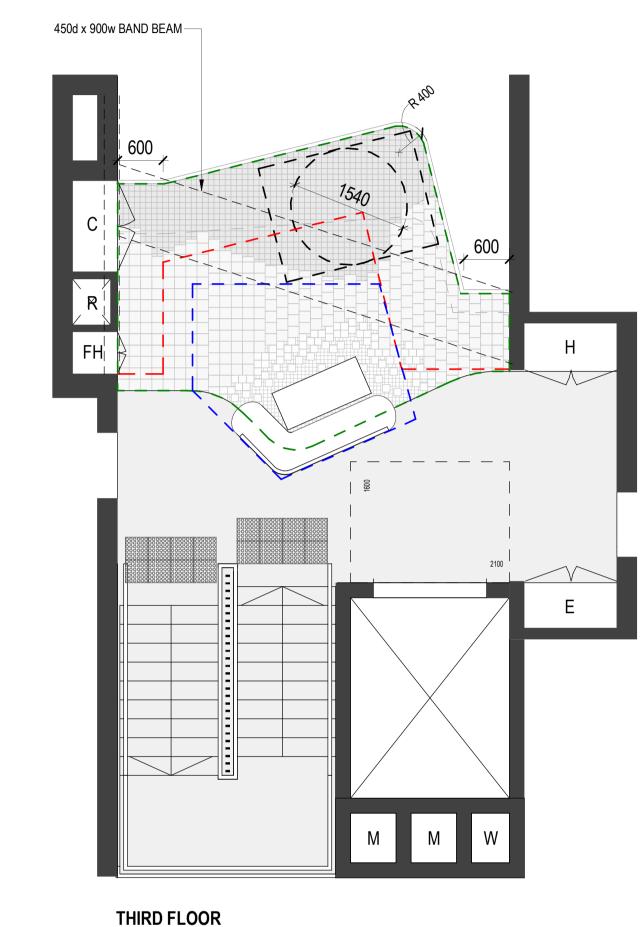

1 BRACKISH SPACES DETAIL PLANS
SCALE 1:50

S/S CAPPING OVER ANGLE

BRACKISH SPACE TILE ON SCREED

1-100 FALL

SCREED TO FALL

FALL

WATERPROOFING

ANGLE TRIM AT CONCRETE RIDGE WITH WATERPROOFING OVER

PEDESTAL FLOORING

2 TYP. BRACKISH SPACE TILE JUNCTION DETAIL
SCALE 1:10

0 500 1000 1500 2000 2500 SCALE BAR - 1:50

NOT FOR CONSTRUCTION. THESE DETAIL DRAWINGS ARE PRELIMINARY AND INDICATIVE ONLY, AND SUBJECT TO FURTHER AND DETAILED INPUT, DESIGN AND ADVICE BY THE PROJECT TEAM. THEY ARE INCLUDED TO SHOW THE DESIGN INTENT ONLY OF KEY ARCHITECTURAL FEATURES AND ARE NOT FOR CONSTRUCTION.

NSW HOUSING PATTERN BOOK



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NGULUWAY DesignInc	
Gadigal Country	
Level 12, 126 Phillip Street, Sydney NSW 2000	
L 61 2 9005 7100 Pagention@Nauluway decigning com au	


Level 12, 126 Phillip Street, Sydney NSW 2000
+61 2 8905 7100 Reception@Nguluway.designinc.com.au

Nominated Architects
Ian Armstrong 7260 Cathryn Drew-Bredin
Craig Kerslake 7789 Mary Anne McGirr

Pattern Code	SLA02
Name	Small Lot Apartments 02
	by Nguluway DesignInc

Drawing No.	A-420
Name	KEY DETAIL PLANS

Scale AS INDICATED @ A1

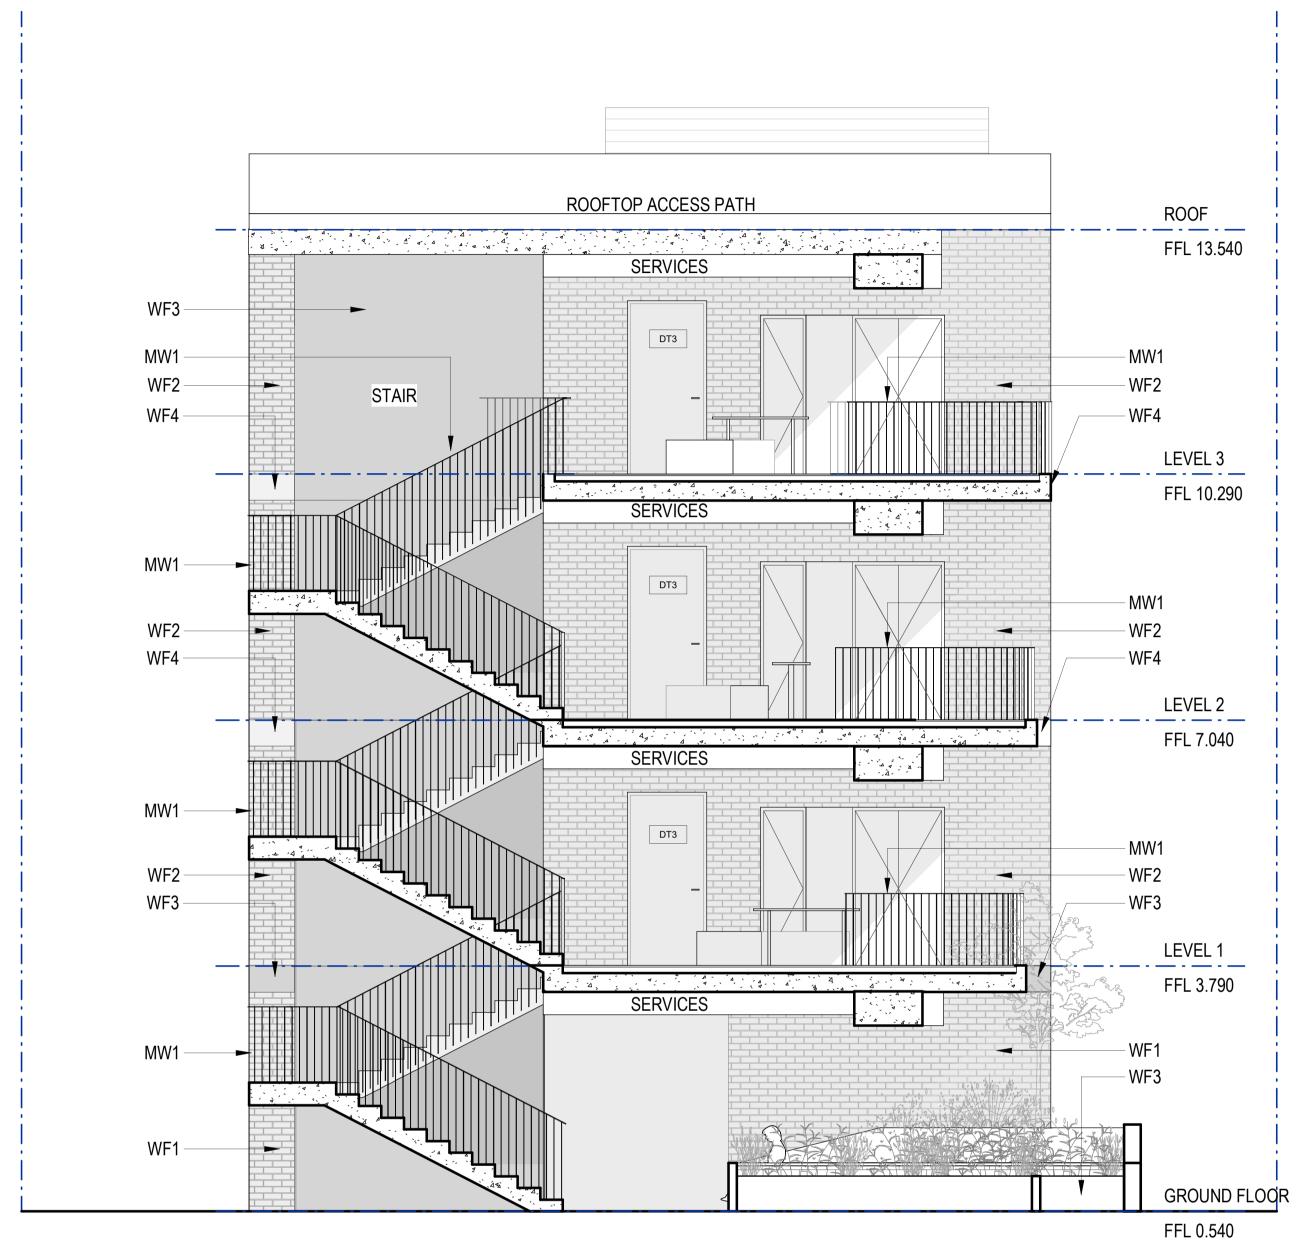

1 SECTION - CENTRAL BRACKISH SPACE 01
SCALE 1:50


NOT FOR CONSTRUCTION. THESE DETAIL DRAWINGS ARE PRELIMINARY AND INDICATIVE ONLY, AND SUBJECT TO FURTHER AND DETAILED INPUT, DESIGN AND ADVICE BY THE PROJECT TEAM. THEY ARE INCLUDED TO SHOW THE DESIGN INTENT ONLY OF KEY ARCHITECTURAL FEATURES AND ARE NOT FOR CONSTRUCTION.

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2 SECTION - CENTRAL BRACKISH SPACE 02
SCALE 1:50

NGII	1 11	WAYDes	ianlna
Gadigal Country Level 12, 126 Phillip +61 2 8905 7100	Street, Sydney N		-igiiiic
Nominated Arc	·	Cathryn Drew-Bredin	7269 10046

Pattern Code	SLA02
Name	Small Lot Apartments 02
	by Nguluway DesignInc

KEY DETAIL SECTIONS

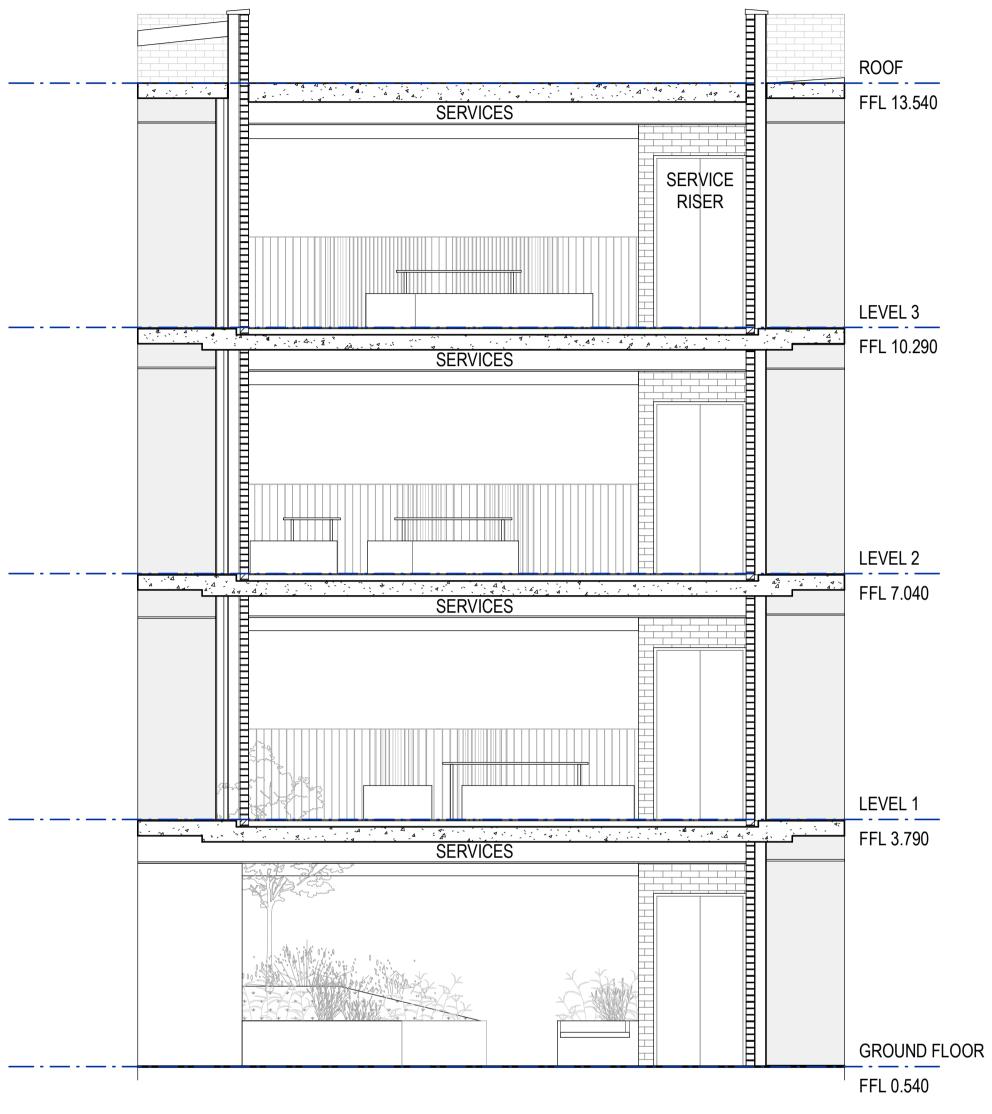A-423


Scale 1:50 @ A1

Drawing No.


Name

Areas and yields


GFA CALCULATIONS

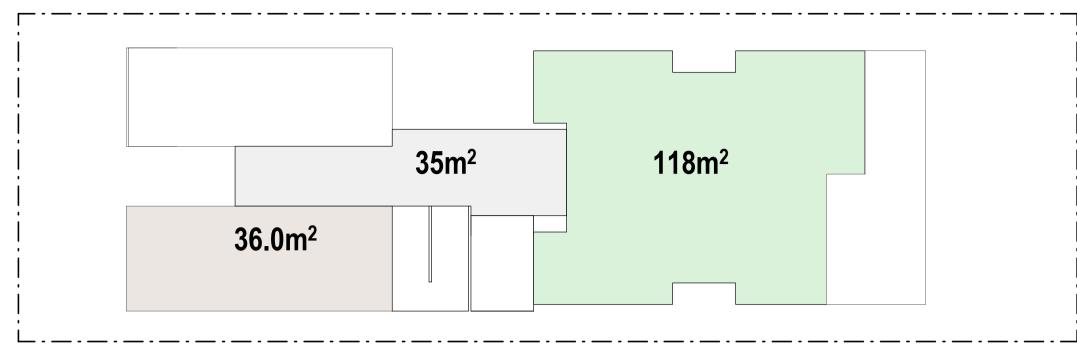


GROUND FLOOR

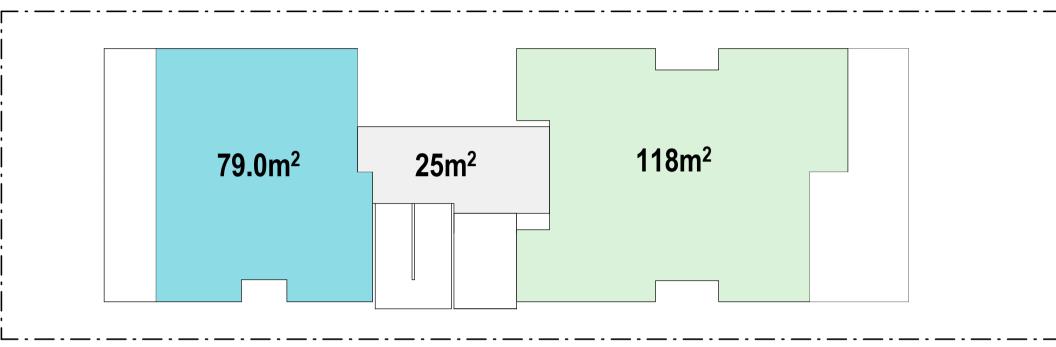

LEVEL 01

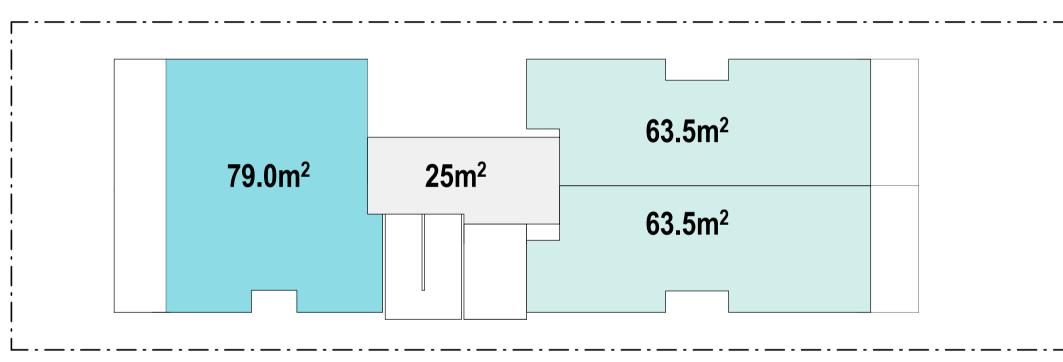

LEVEL 02

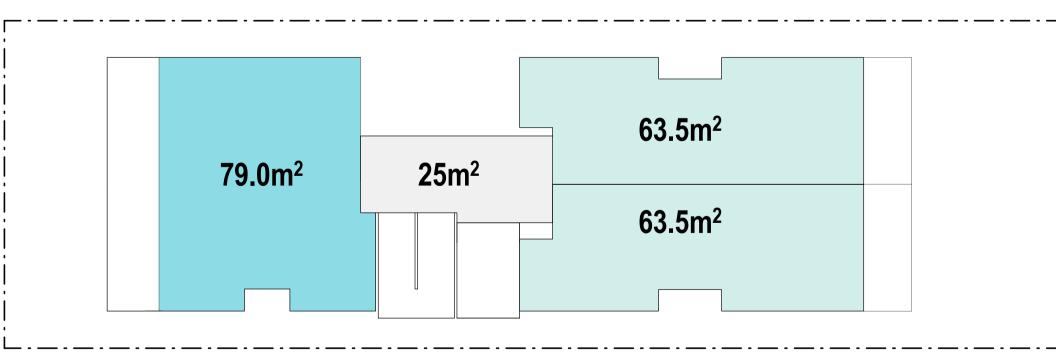

LEVEL 03

4 STOREYS

BASE PATTERN
SITE WIDTH 16.6m
SITE LENGTH 42m
SITE AREA 697.2m²

GFA		GFA	
RESIDENTIAL GFA		COMMUNAL & WAS	STE ROOM
GROUND	118m ²	GROUND	71m ²
LEVEL 01	197m ²	LEVEL 01	25m ²
LEVEL 02	206m ²	LEVEL 02	25m ²
LEVEL 03	206m ²	LEVEL 03	25m ²
ROOF	N/A	ROOF	N/A
TOTAL	$727m^{2}$	TOTAL	146m

TOTAL GFA873m²FSR1.25:1

UNIT MIX

TOTAL

 □ STUDIO
 0 - 00.0%

 □ 1B
 4 - 44.4%

 □ 2B
 3 - 33.3%

 □ 3B
 2 - 22.2%

3 STOREYS

BASE PATTERN

SITE WIDTH 16.6m

SITE LENGTH 42m

SITE AREA 697.2m²

GFA COMMUNAL & WASTE ROOM RESIDENTIAL GFA 118m² **GROUND** GROUND LEVEL 01 LEVEL 01 25m² LEVEL 02 206m² LEVEL 02 ROOF ROOF N/A N/A 121m² TOTAL 521m² TOTAL

 TOTAL GFA
 642m²

 FSR
 0.92:1

UNIT MIX

STUDIO

1B

2 - 33.3%

2B

2B

2 - 33.3%

2 - 33.3%

TOTAL

6

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,	treet, Sydney NSW 2000
+61 2 8905 7100	Reception@Nguluway.designinc.com.au


Pattern Code	SLA02
Name	Small Lot Apartments 02
	by Nguluway DesignInc

Drawing No. A-430

Name AREA CALCULATIONS

Scale AS INDICATED @ A1

DEEP SOIL, LANDSCAPE & COMMUNAL AREA CALCULATIONS

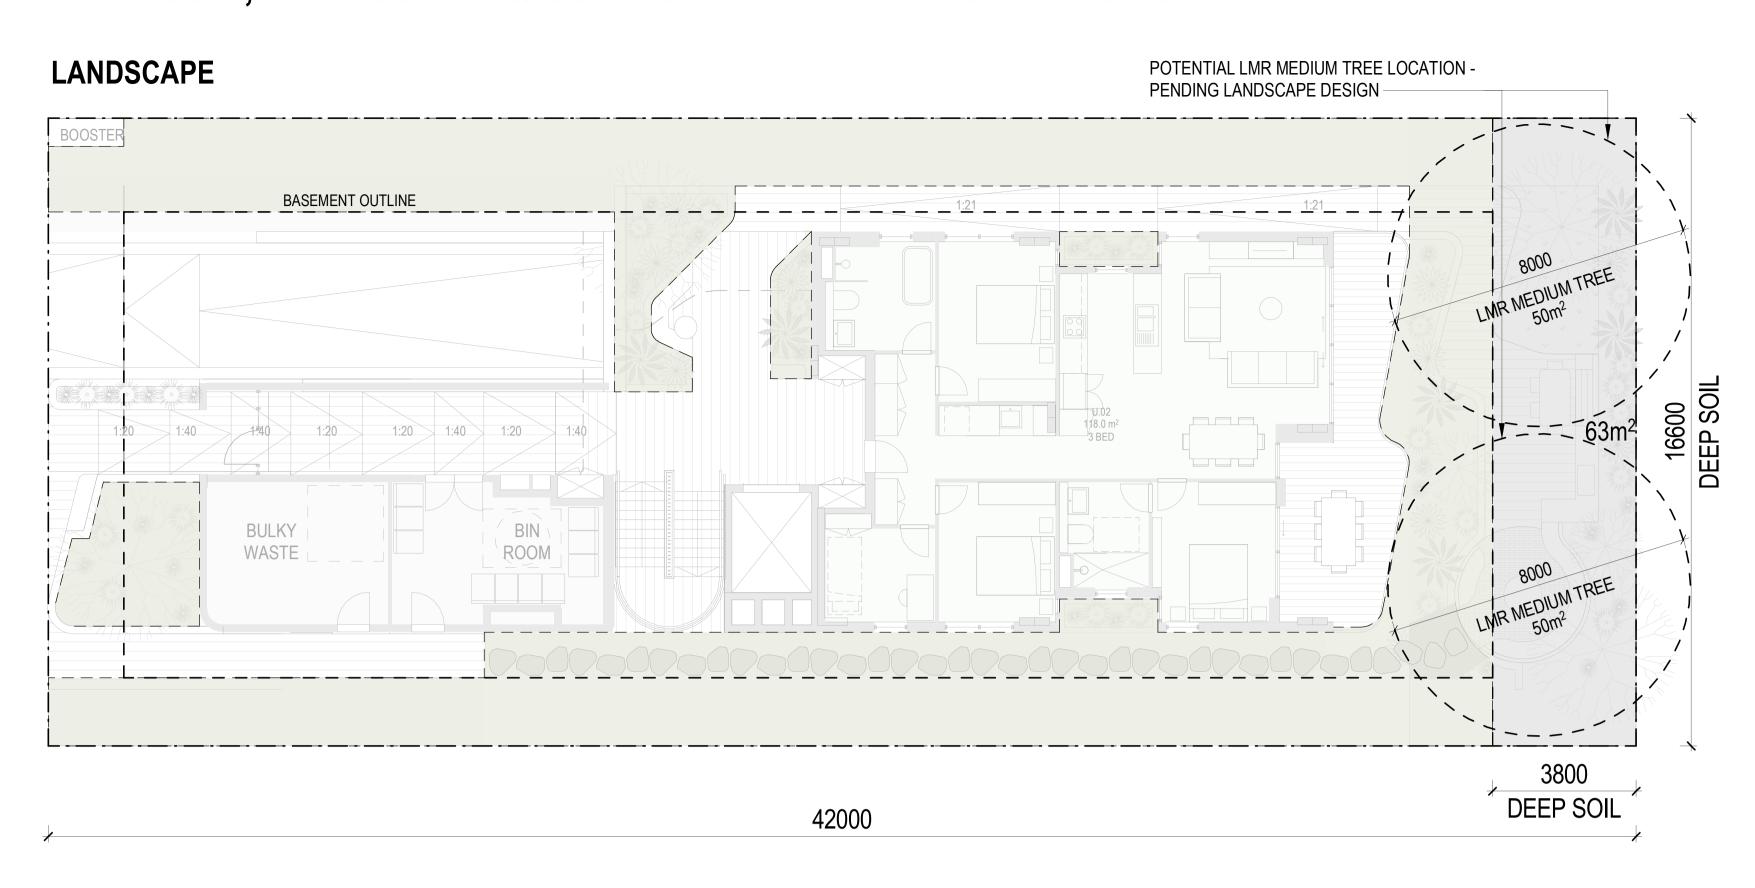

DEEP SOIL & LANDSCAPED AREA COMMUNAL AREA			COMMUNAL AREA	
	SITE AREA: DEEP SOIL AREA PERCENTAGE OF SITE: REQ. FOR SITE	697.2m ² 63.0m ² 9% 7%	GROUND FLOOR CENTRAL COMMUNAL SPACE: GROUND FLOOR REAR COMMUNAL SPACE: LEVEL 01 COMMUNAL AREA: LEVEL 02 COMMUNAL AREA:	109.0m ² 17.0m ² 16.0m ²
	ADD. LANDSCAPED AREA PERCENTAGE OF SITE	241m ² 34.6%	LEVEL 03 COMMUNAL AREA: TOTAL COMMUNAL AREA: PERCENTAGE OF TOTAL SITE: REQ. TOTAL SITE	15.0m ² 195.0m ² 28.0% 25.0%
	COMBINED PERCENTAGE OF SITE	295m ² 43.6%		
	LMR TREE CANOPY MIN. REQUIREMENT: ALLOWED FOR:	15% SITE AREA TRE 14.3% SITE AREA TR		

COMMUNAL AREAS



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	Gadigal Country	troot Cudou NCW 2000
l	+61 2 8905 7100	treet, Sydney NSW 2000 Reception@Nguluway.designinc.com.au
I	3000 7 700	

Name

Pattern Code SLA02


Name Small Lot Apartments 02


by Nguluway DesignInc

Drawing No. A-431

Name AREA CALCULATIONS


GBA CALCULATIONS

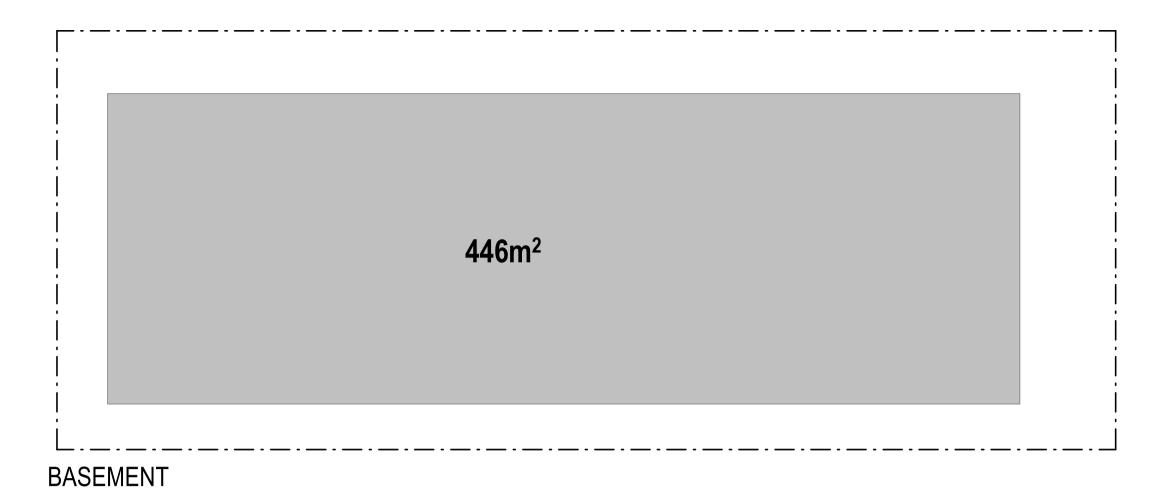


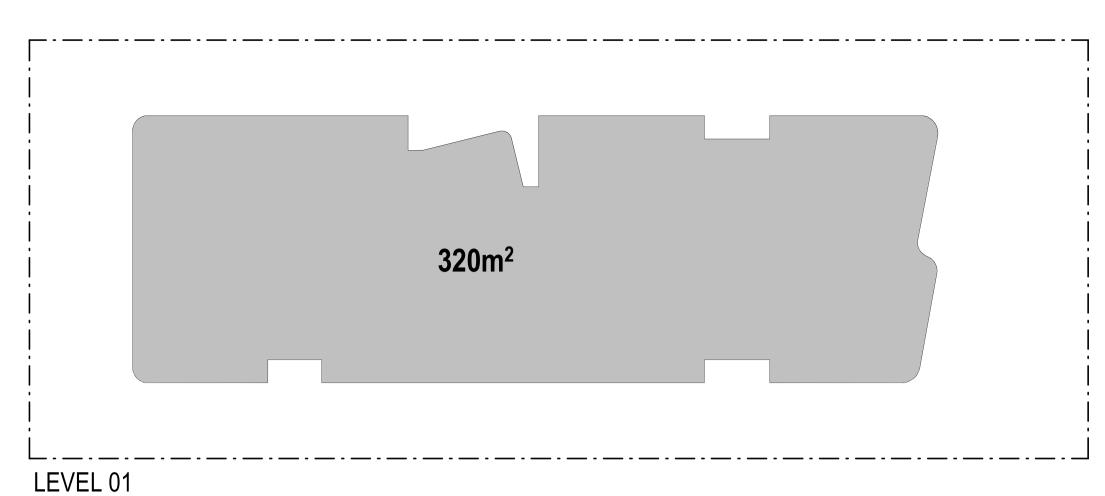

4 STOREYS

BASEMENT LEVEL 03 TOTAL GBA

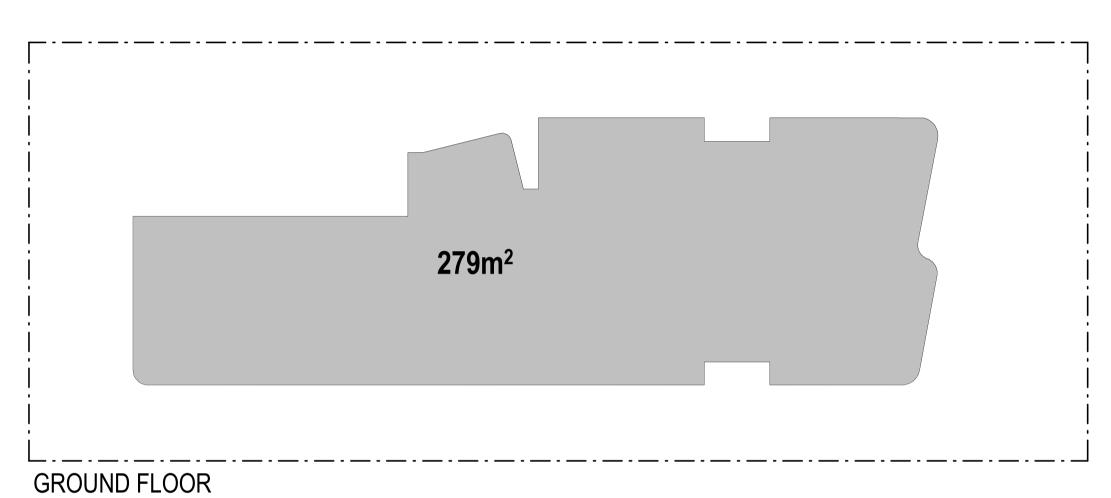

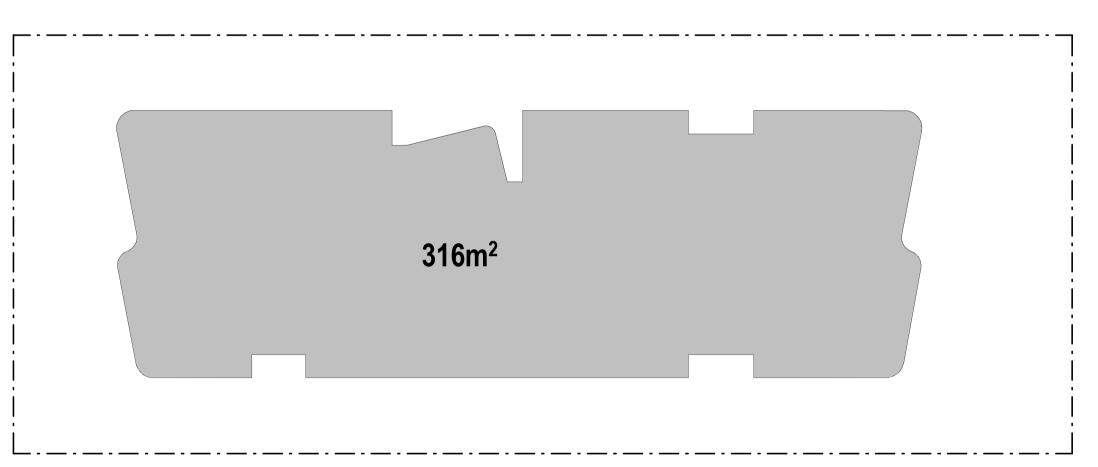

LEVELS 02 & 03

NSW HOUSING PATTERN BOOK

GOVERNMENT ARCHITECT NEW SOUTH WALES

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NGULUWAY **DesignInc** Gadigal Country Level 12, 126 Phillip Street, Sydney NSW 2000 +61 2 8905 7100 Reception@Nguluway.designinc.com.au Cathryn Drew-Bredin Mary Anne McGirr

SLA02 Pattern Code

Name

Small Lot Apartments 02

by Nguluway DesignInc


Drawing No.


AREA CALCULATIONS Name

A-434

1:150 @ A1 Scale

NSA CALCULATIONS

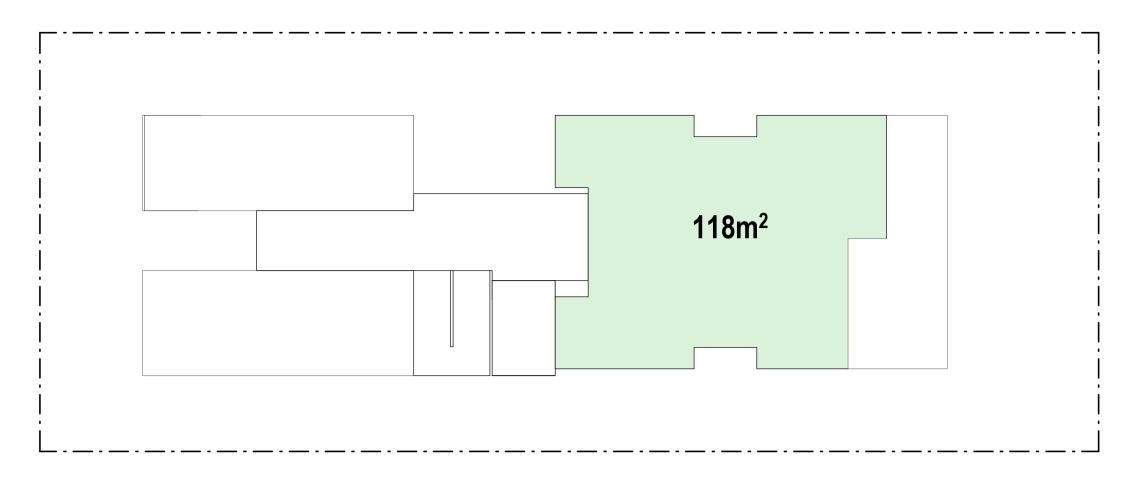


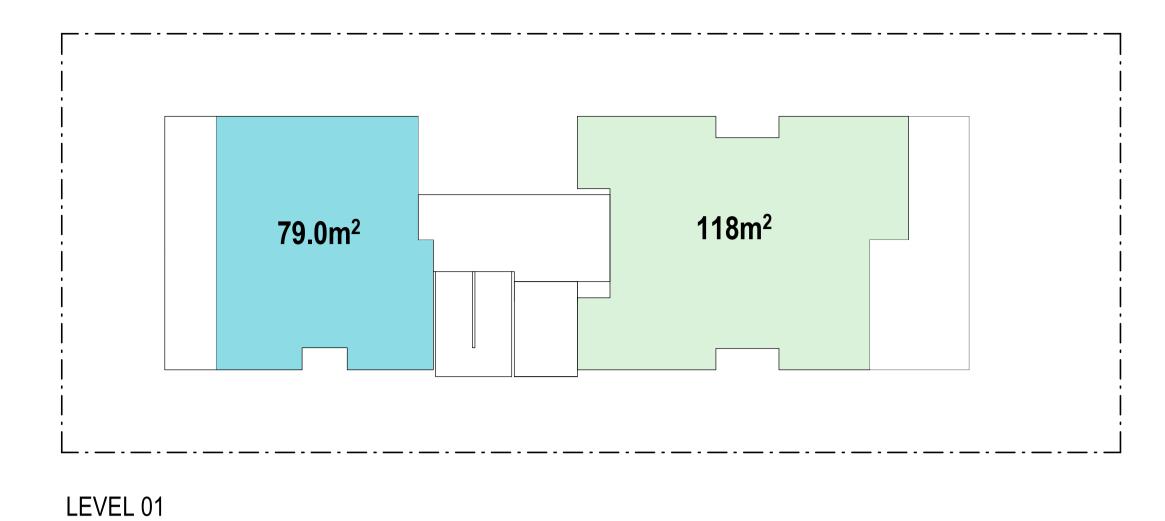




RESIDENTIAL NSA	
GROUND	118m ²
LEVEL 01	197m²
LEVEL 02	206m ²
LEVEL 03	206m ²
ROOF	N/A
TOTAL	$727m^2$

GROUND FLOOR

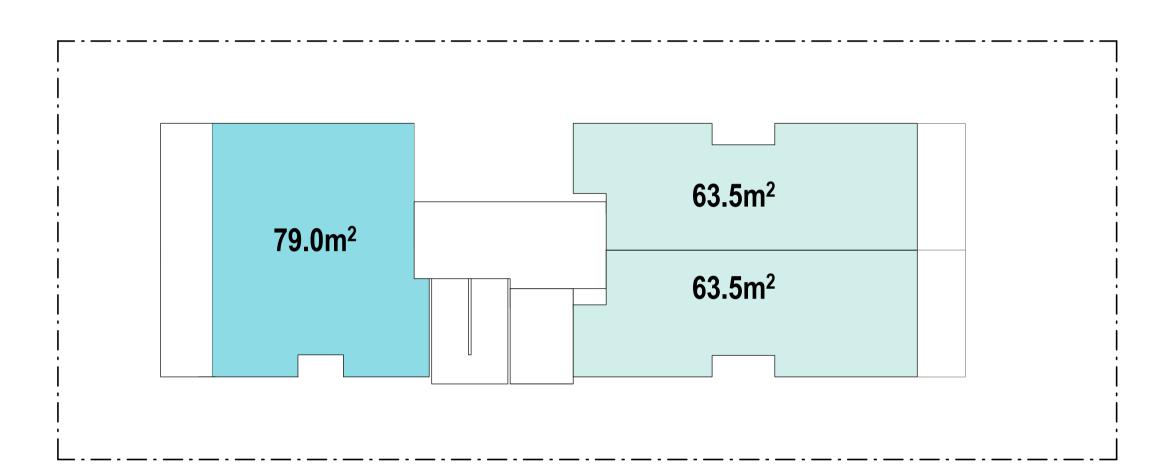

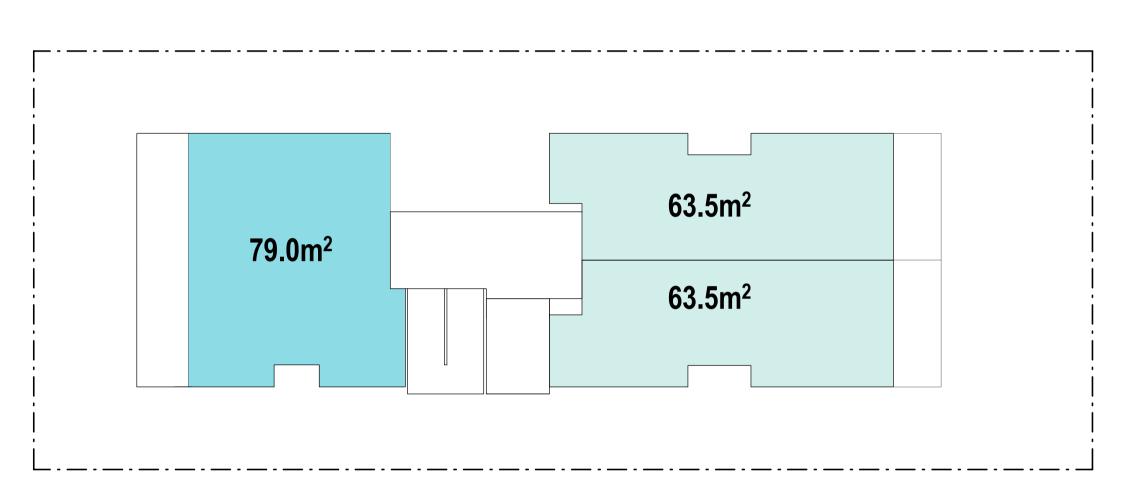

LEVEL 02 LEVEL 03

NSW HOUSING PATTERN BOOK

GOVERNMENT ARCHITECT NEW SOUTH WALES

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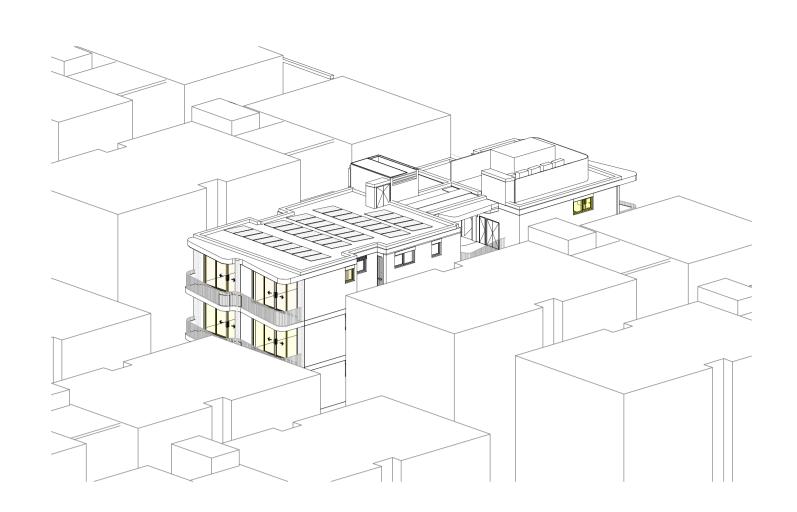
Rev	Date	Description	
Rev 1	Nov 2025	Pattern Book Issue	

-	NGU	LU	WAYDes	ianlne	
-	Gadigal Country Level 12, 126 Phillip +61 2 8905 7100	Street, Sydney N			
	Nominated Arc lan Armstrong Craig Kerslake	7260 7789	Cathryn Drew-Bredin Mary Anne McGirr	7269 10946	


Pattern Code	SLA02	Drawing No.	A-435
Name	Small Lot Apartments 02 by Nguluway DesignInc	Name	AREACALC
		Scale	1:150 @ A1

A-435 **AREACALCULATIONS**


Supplementary drawings




1 JUNE 21 - 9AM

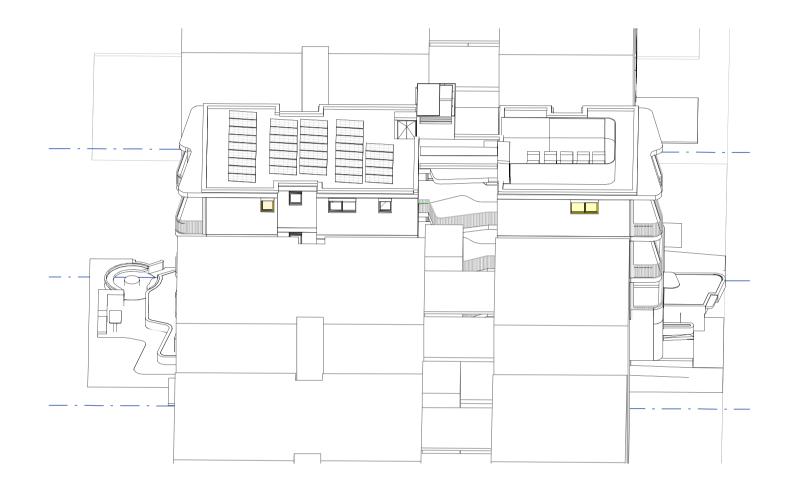


4 JUNE 21 - 12PM

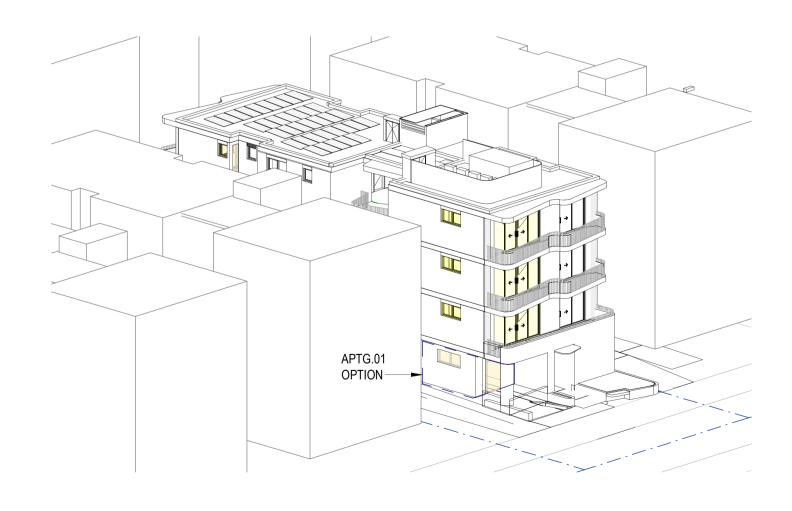

7 JUNE 21 - 3PM

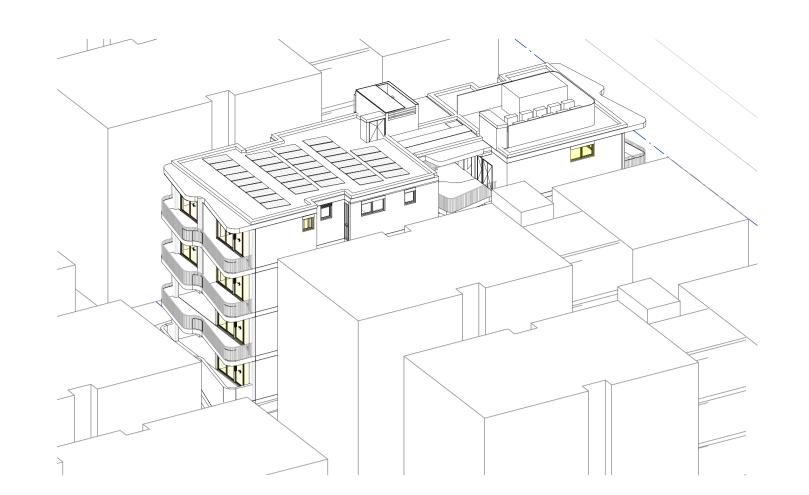


2 JUNE 21 - 10AM

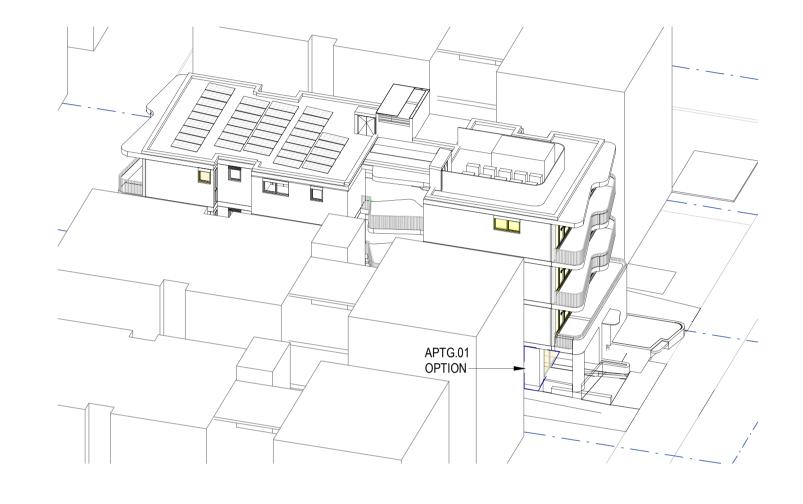


5 JUNE 21 - 1PM

APT NO.	HOURS OF SUNLIGHT	COMPLIANT
APTG01*	1PM - 3PM	YES
APTG02	10AM - 11AM	NO
APT101	1PM - 3PM	YES
APT102	10AM - 11AM	NO
APT201	1PM - 3PM	YES
APT202	9AM - 11AM	YES
APT203	9AM - 10AM	NO
APT301	9AM - 3PM	YES
APT302	9AM - 3PM	YES
APT303	9AM - 10AM	NO

*APTG01 ONLY APPLICABLE TO NO PARKING VARIANT

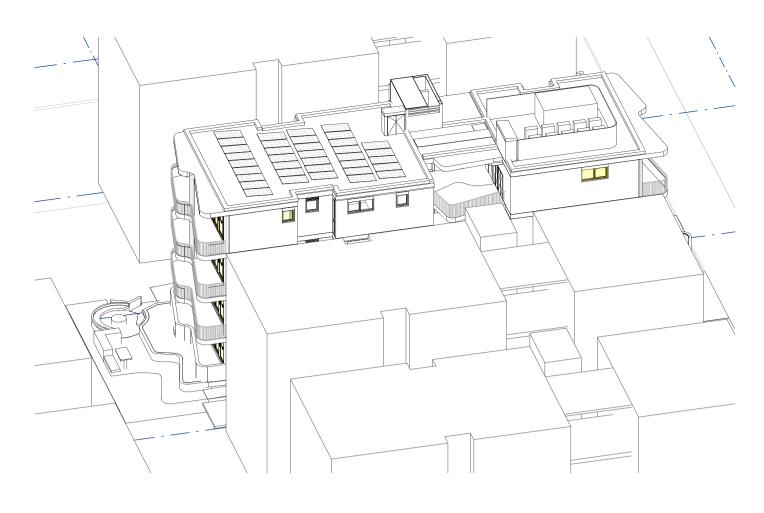

3 JUNE 21 - 11AM

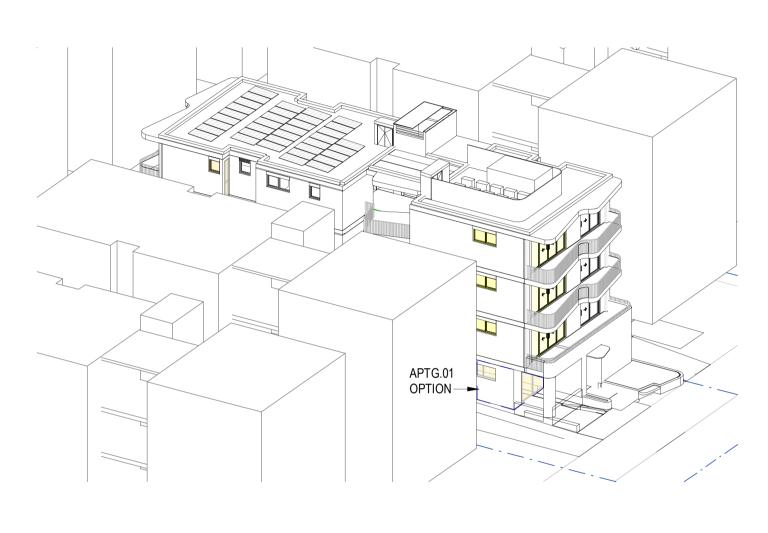

6 JUNE 21 - 2PM

5/9 APARTMENTS RECEIVE MIN. 2HRS SUNLIGHT 56% COMPLIANCE, MIN. 70% REQUIRED

MODELLING BASED ON FUTURE CONTEXT BUILT UP TO SAME DEVELOPMENT STANDARDS AS PROPOSED PROJECT

NSW HOUSING PATTERN BOOK



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_	NGULUWAY DesignInc
_	Gadigal Country Level 12, 126 Phillip Street, Sydney NSW 2000 +61 2 8905 7100 Reception@Nguluway.designinc.com.au

el 12, 126 Phillip Street, Sydney NSW 2000
1 2 8905 7100 Reception@Nguluway.designinc.com.au

| minated Architects |
| Armstrong | 7260 Cathryn Drew-Bredin | 7269 |
| ig Kerslake | 7789 Mary Anne McGirr | 10946

Pattern Code	SLA02
Name	Small Lot Apartments 02


by Nguluway DesignInc

Drawing No.
Name


A-500

NORTH TO THE SIDE BOUNDARY

SOLAR ACCESS DIAGRAMS

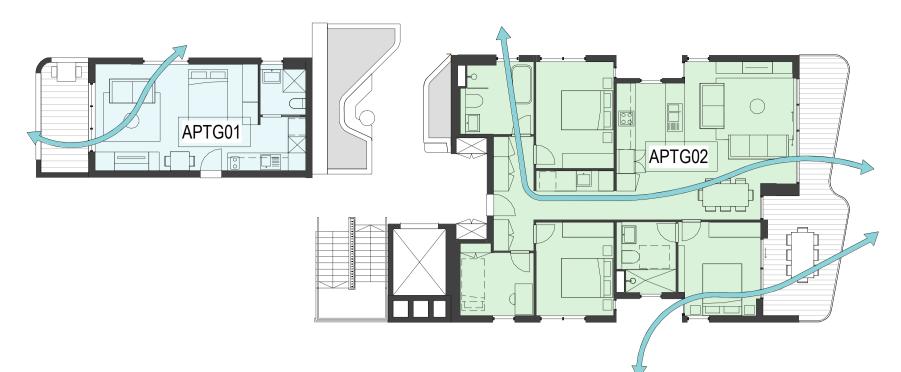


GROUND LEVEL

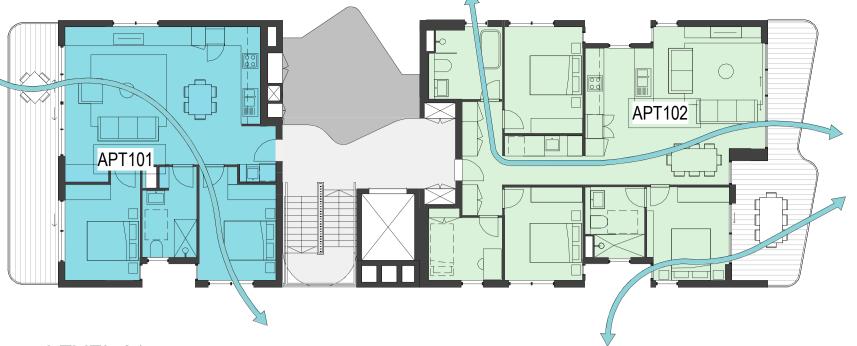


LEVEL 01



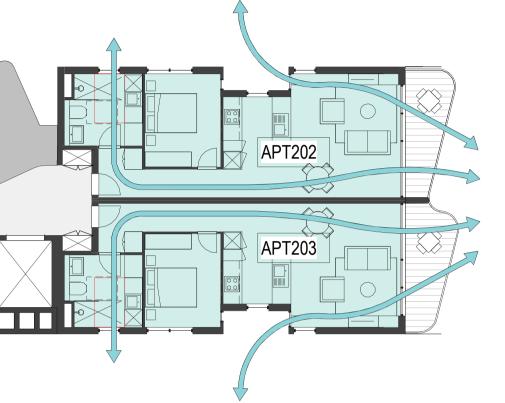

LEVEL 02

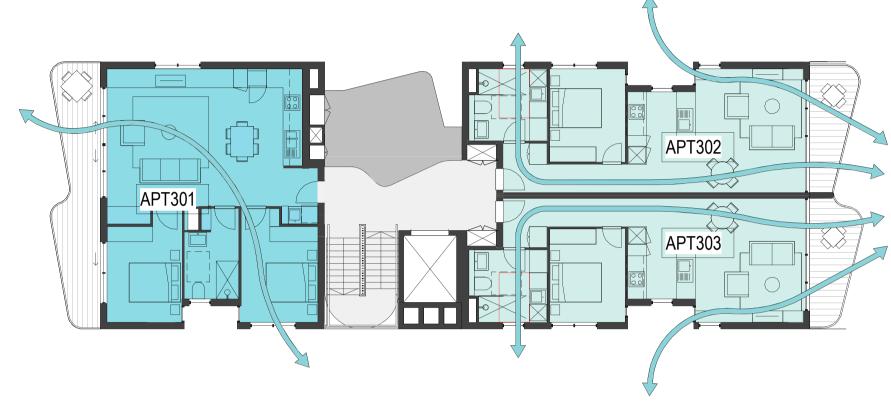

LEVEL 03

CROSS VENTILATION SUMMARY

APT NO.	CROSS VENTILATED
APTG01*	YES
APTG02	YES
APT101	YES
APT102	YES
APT201	YES
APT202	YES
APT203	YES
APT301	YES
APT302	YES
APT303	YES
*APTG01 ON	LY APPLICABLE TO NO PARKING VARIANT

BASEMENT PARKING

9/9 APARTMENTS CROSS-VENTILATED 100% COMPLIANCE, MIN. 60% REQUIRED

> 0 1 2 3 4 5 SCALE BAR - 1:100

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-	


NGU	L U WAY DesignInc
Gadigal Country	
Level 12, 126 Phillip S	treet, Sydney NSW 2000
+61 2 8905 7100	Reception@Nguluway.designinc.com.au

Cathryn Drew-Bredin Mary Anne McGirr

,	Name	Sm
		by l

Pattern Code	SLA02
Name	Small Lot Apartments 02
	by Nguluway DesignInc

Drawing No.	A-510

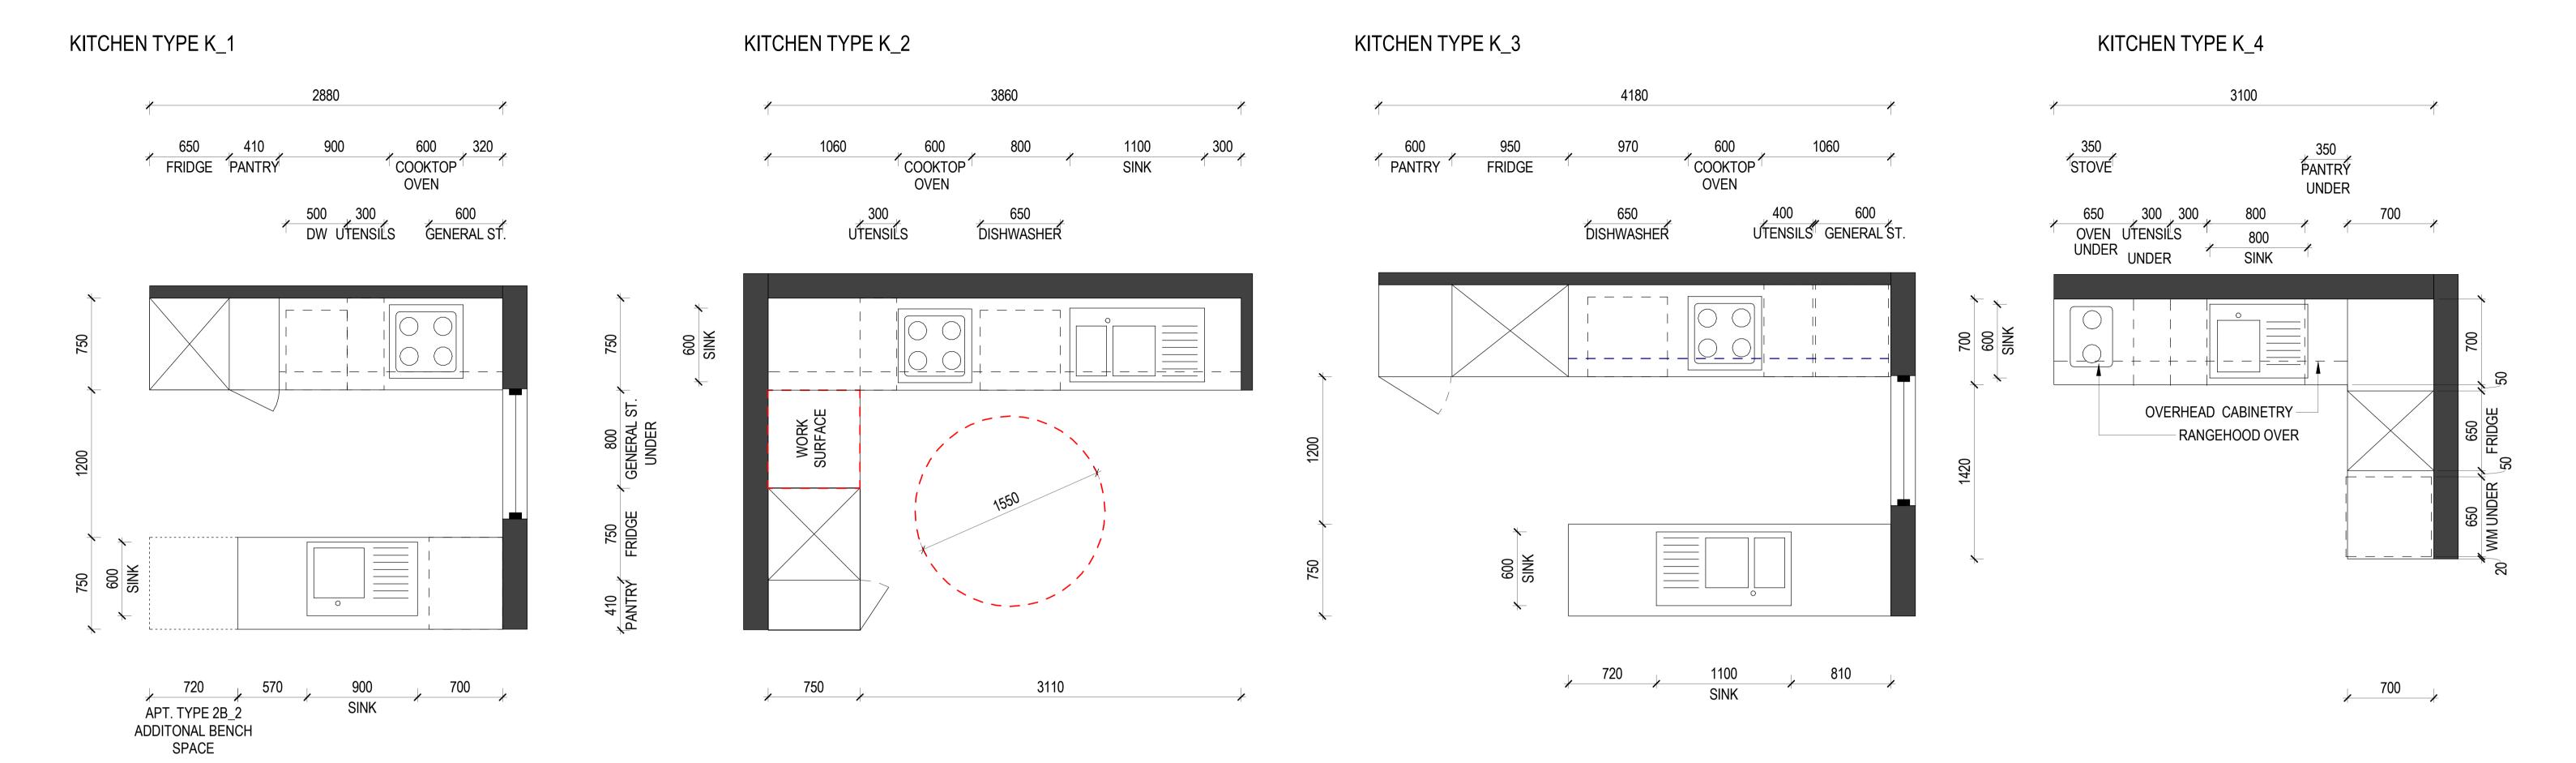

WET AREA DRAWINGS

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Rev	Date	Description
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Gadigal Country	E & WAI Boolgiiii
,	eet, Sydney NSW 2000

Pattern Code	SLA02
Name	Small Lot Apartments 02
	by Nguluway DesignInc

1:25 @ A1

Name

Scale

BATHROOM TYPE B_1a 2700 900 240 500 280 700 90 SHOWER TOILET 002

- 1200x900mm CLEAR ZONE


900 240 500 280 700 90 SHOWER TOILET 8 SINK REFER A-522 LAUNDRY TYPE L_1 1200x9900mm CLEAR ZONE

BATHROOM TYPE B_1b


2710 90 700 280 500 240 900 SINK TOILET SHOWER 008 1200x900mm


CLEAR ZONE


BATHROOM TYPE B_2

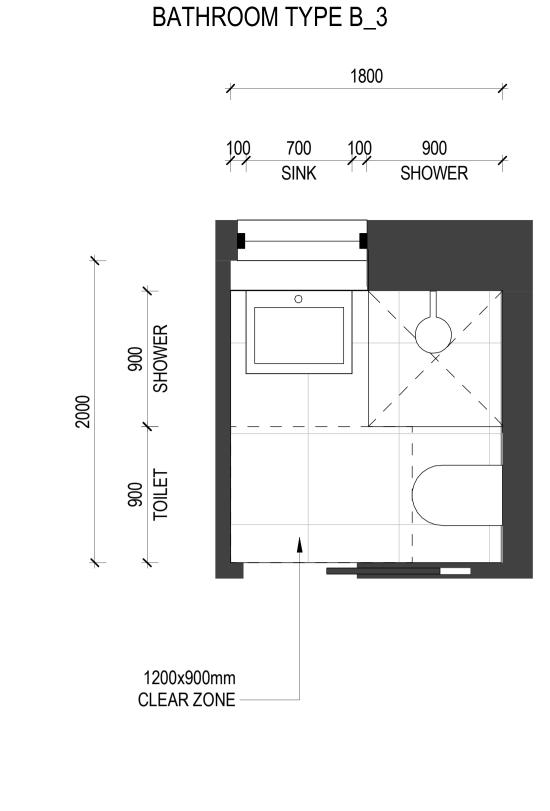

BATHROOM TYPE B_4a

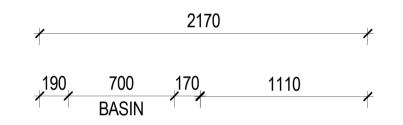

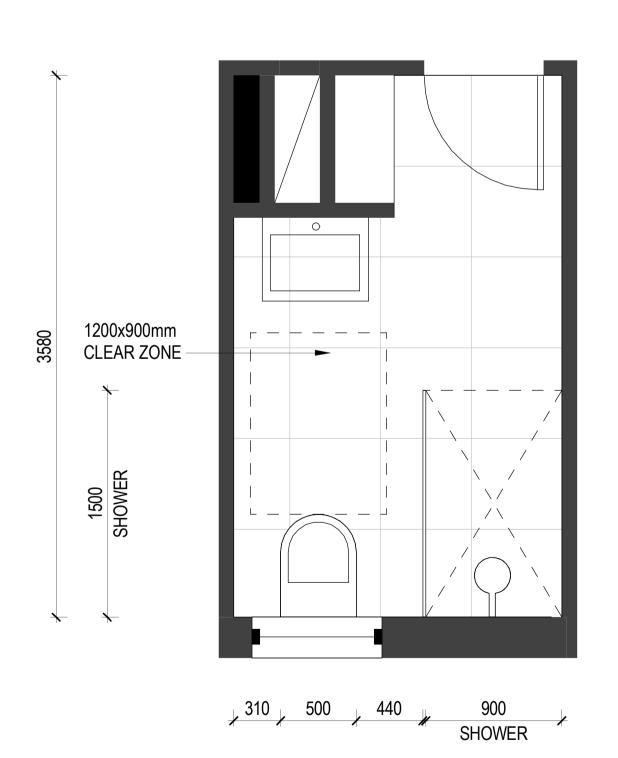

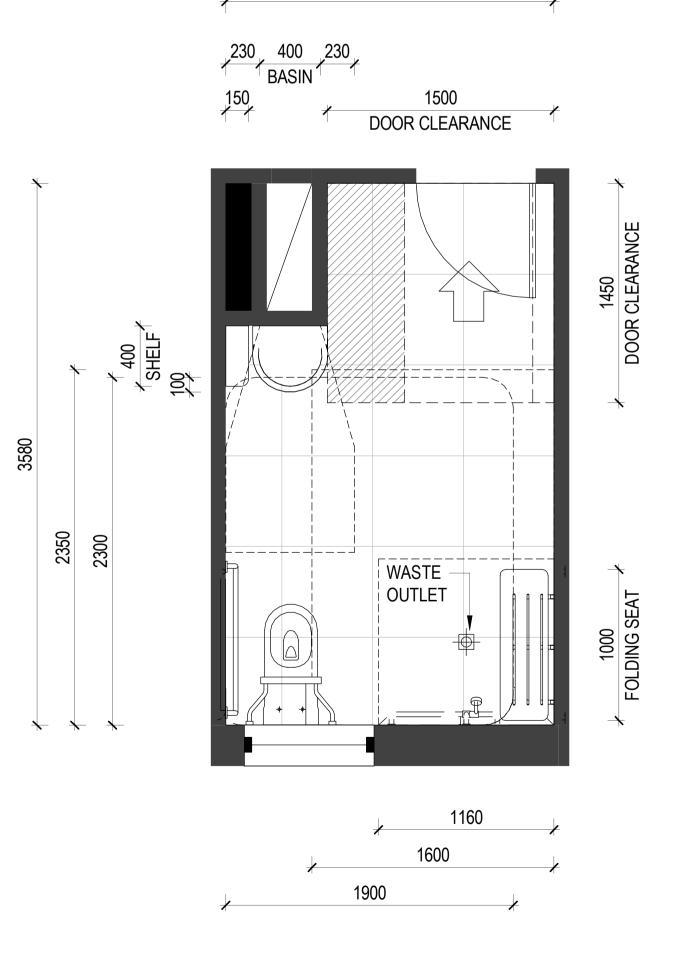

BATHROOM TYPE B_4b


0 250 500 750 1000 1250 SCALE BAR - 1:25

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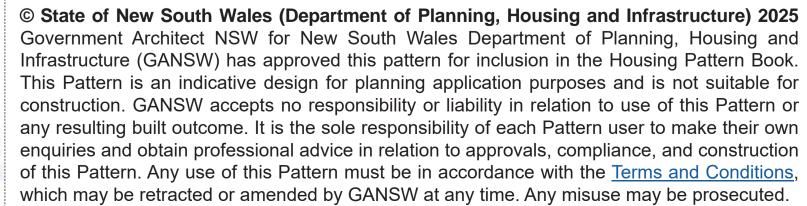
Rev	Date	Description
Rev 1	Nov 2025	Pattern Book Issue



LAUNDRY TYPE L_3 LAUNDRY TYPE L_1 LAUNDRY TYPE L_2 LAUNDRY TYPE L_4 2860 1430 900 STORAGE 650 WM & DR UNDER 650 WM UNDER 650 530 WM & DR UNDER UNDER REFER A-520 KITCHEN LAYOUT TYPE K_4 700 500 TUB 200 SINK IN 800 500 TUB KITCHEN OVERHEAD SHELVING 2190 BENCHTOP 1970 BENCHTOP STUDIO LAUNDRY UTILISES KITCHEN SINK & BENCHTOP



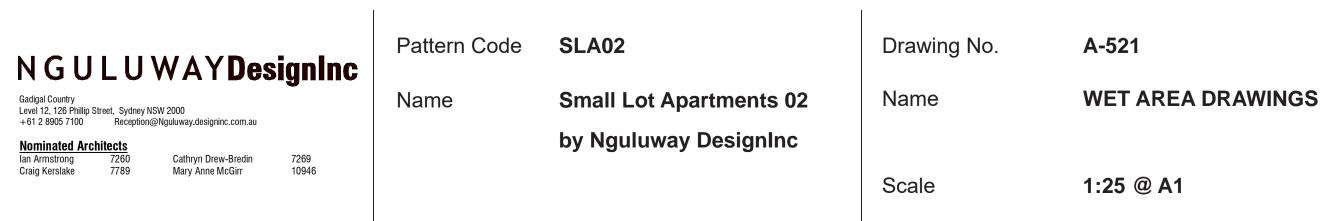






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Pattern Code	SLA02
Name	Small Lot Apartments 02
	by Nguluway DesignInc





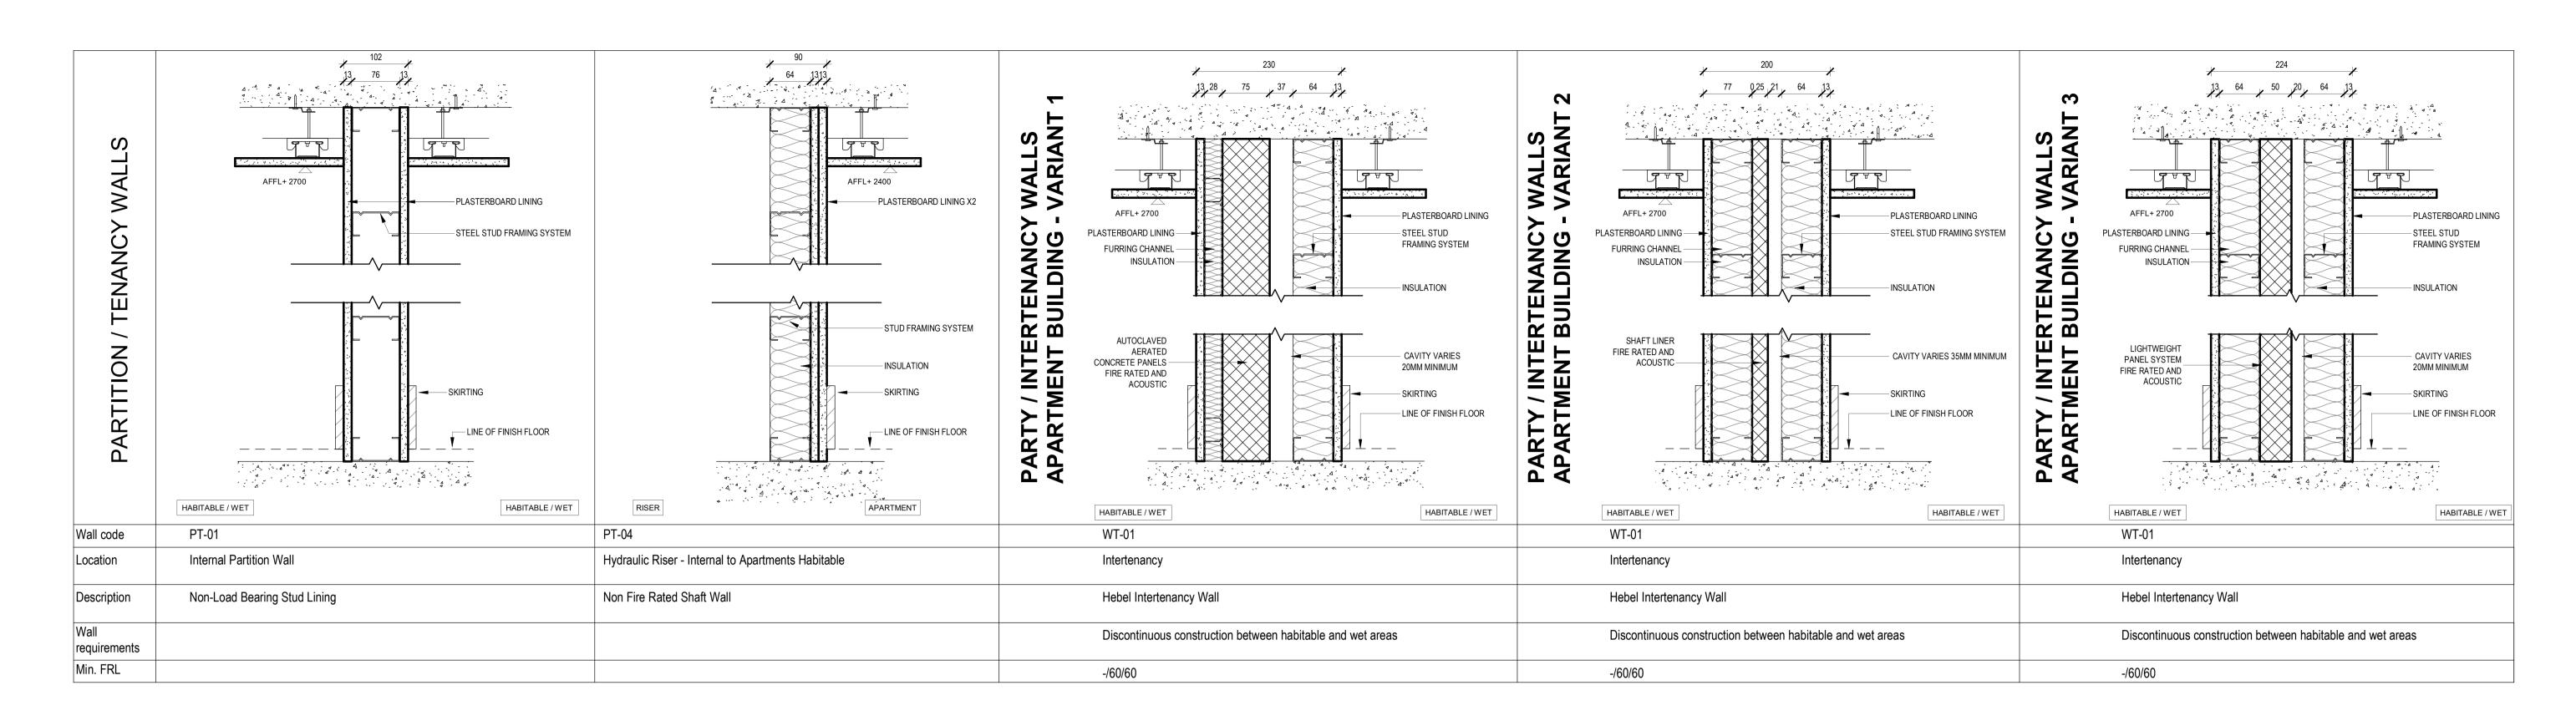

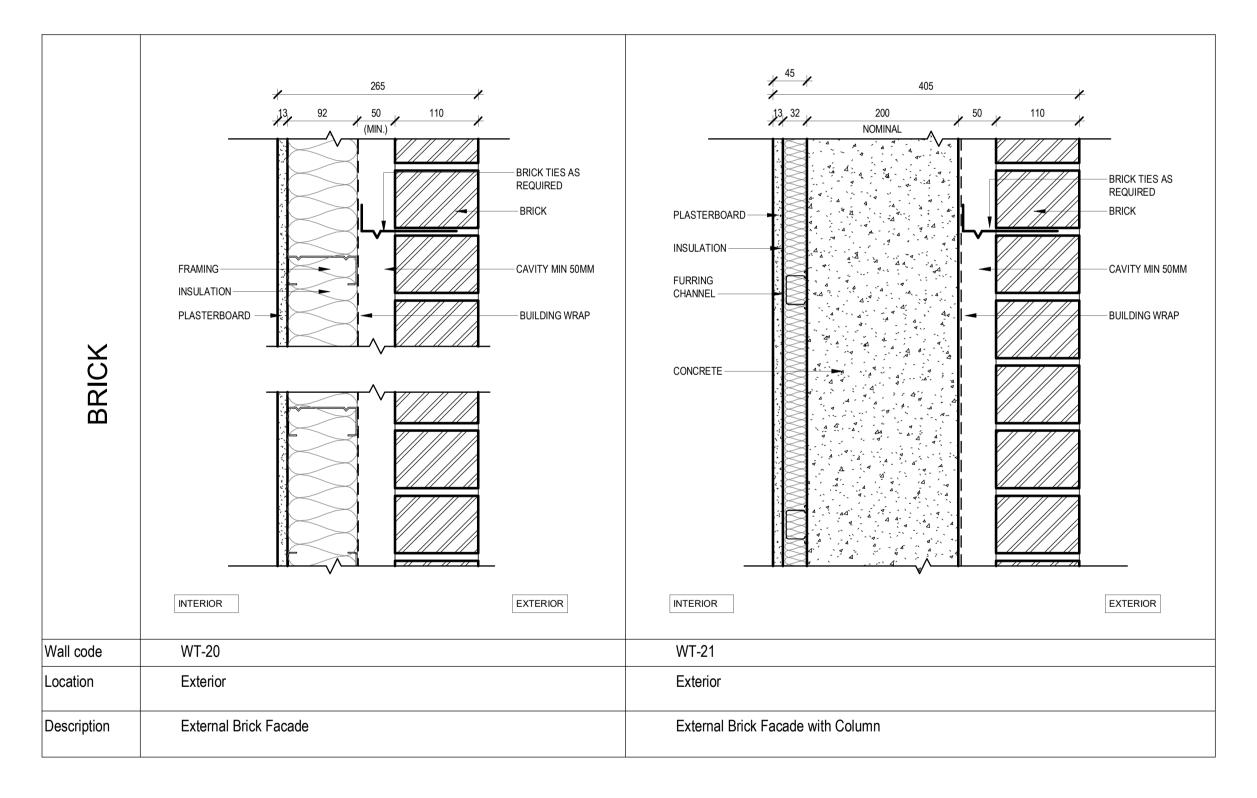0 50 100 150 200 250 SCALE BAR - 1:5

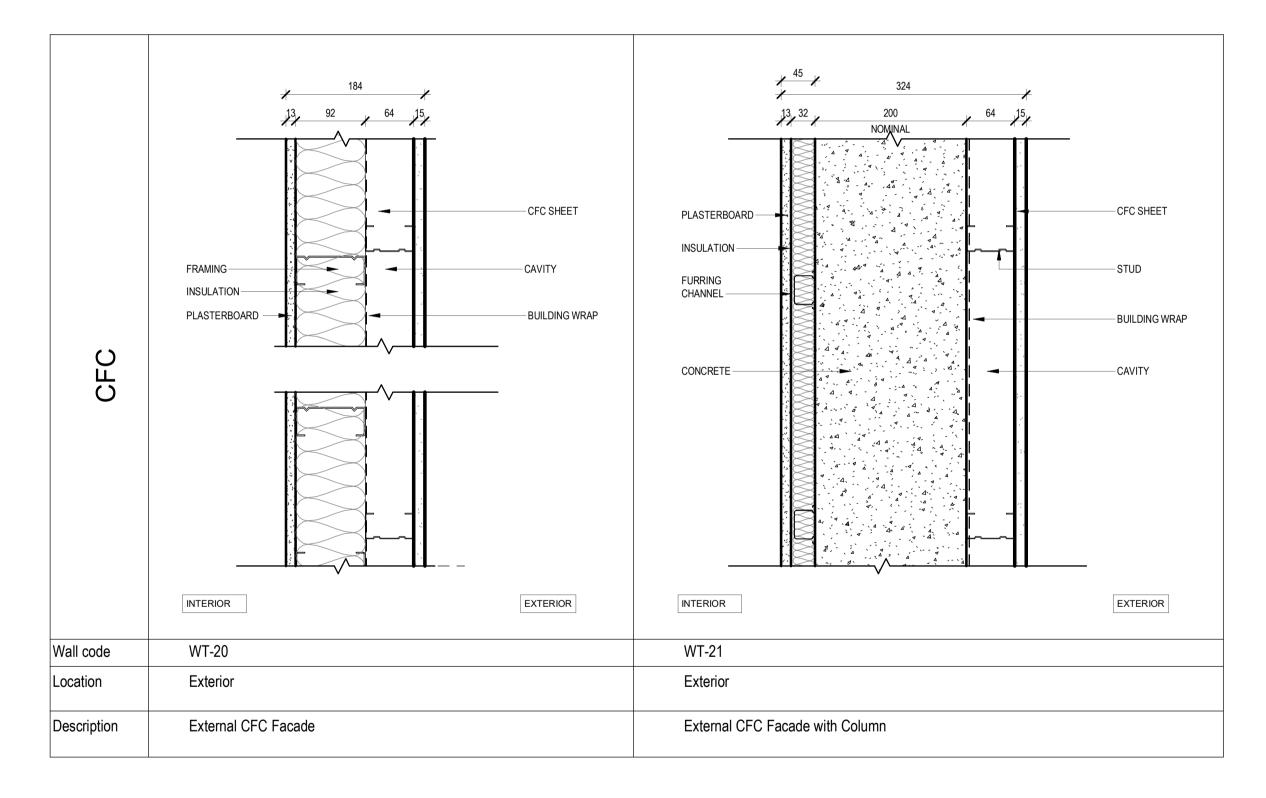NSW HOUSING PATTERN BOOK



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Drawing No.	A-530
Name	WALL TYP

Scale 1:5 @ A1